

RENDERING (LANEWAY VIEW) FOR REFERENCE ONLY

CONTACTS **ARCHITECT GRADING CONSULTANT** STRUCTURAL DESIGNER **MECHANICAL DESIGNER** LANESCAPE ARCHITECTURE INC. SUITE 200 - 282 RICHMOND ST E., TORONTO, ON M5A 1P4 info@lanescape.ca 416 414 9944 x0 DDAWING LIST


ARCHITECTURAL	MECHANICAL
A0.0a COVER SHEET A0.0b COVER SHEET A0.1 SITE PLAN & PROJECT NOTES A0.2 DEMOLITION, EXCAVATION, CONSTRUCTION PLAN & PROJECT NOTES A1.0 PROPOSED GROUND FLOOR PLANS A1.1 SLAB & ROOF PLAN A2.0 BUILDING ELEVATIONS A3.0 BUILDING SECTIONS A5.0 DETAILS A8.0 PROJECT SCHEDULES	LOT GRADING

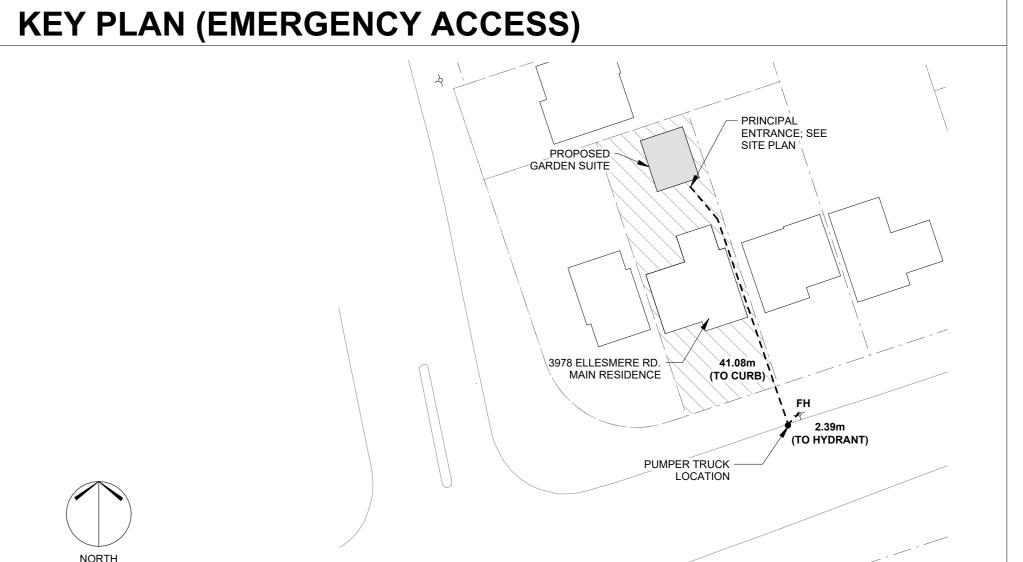

SITE SECTION (BY-LAW DIAGRAM)

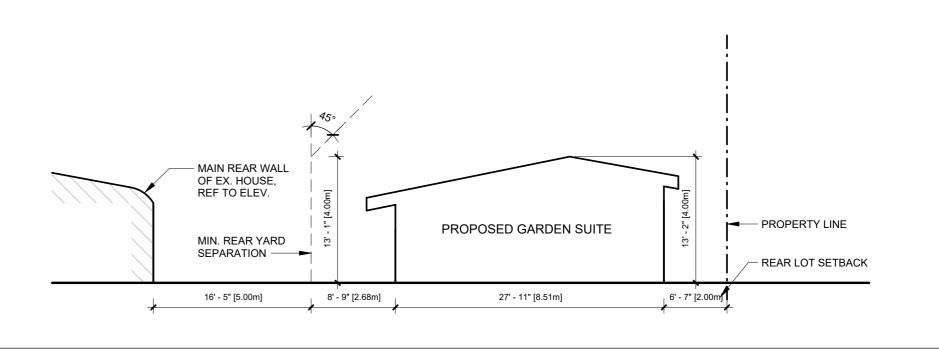

REAR ELEVATION OF EXISTING HOUSE

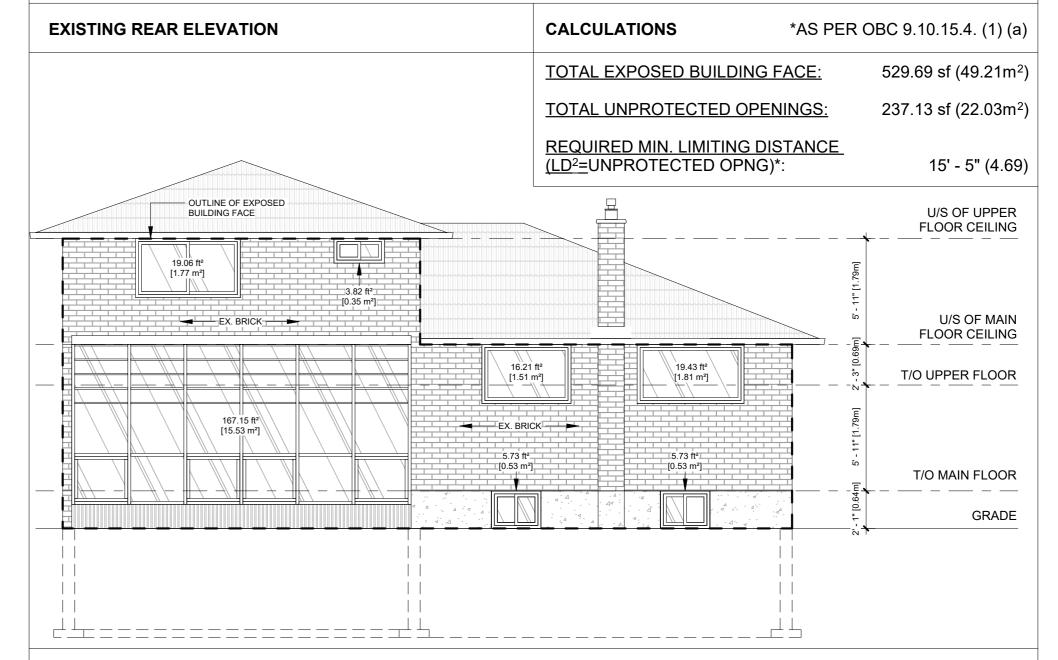

GENERAL NOTES

ALL WORK SHALL BE CARRIED OUT IN ACCORDANCE WITH THE LATEST EDITION OF THE ONTARIO BUILDING CODE, THE NATIONAL FIRE CODE, THE OCCUPATIONAL HEALTH AND SAFETY


ALL CONTRACTORS SHALL FAMILIARIZE THEMSELVES WITH THE SITE AND EXISTING CONDITIONS PRIOR TO SUBMITTING PRICING. THE CONTRACTOR SHALL PROMPTLY REPORT ANY DISCREPANCIES BETWEEN DRAWINGS OR SITE CONDITIONS TO THE PROJECT MANAGER PRIOR TO COMMENCING WORK.

- ONTARIO BUILDING CODE (OBC).
- 2. DRAWINGS NOT TO BE SCALED
- 3. CONTRACTORS TO VISIT SITE AND FAMILIARIZE WITH ALL CONDITIONS PRIOR TO
- 4. ALL JOISTS TO RECEIVE CROSS-BRIDGING AS PER OBC REQUIREMENTS. SOLID

6. TRIPLE JOISTS UNDER ALL LOAD BEARING PARTITIONS. HEADER JOISTS TO BE

SIDES OF WOOD BEAM TRIMMERS AND HEADERS. INSTALL HANGERS IN

- BRIDGING TO BE USED OVER INTERIOR BEARING WALLS/BEAMS.
- 5. DOUBLE JOISTS UNDER ALL PARALLEL PARTITIONS.
- DOUBLED IN CONDITIONS WHERE THE FLOOR OPENING EXCEEDS 4'-0" TO A MAX. OF PROVIDE GALV METAL JOIST HANGERS FOR SUPPORT OF JOISTS FRAMING INTO
- ACCORDANCE WITH MANUFACTURERS' WRITTEN INSTRUCTIONS. THIS DOCUMENT IS NOT FOR CONSTRUCTION, UNLESS IT HAS BEEN INDICATED AS 'ISSUED FOR CONSTRUCTION'
- 1. ALL WORK TO BE CARRIED OUT IN ACCORDANCE WITH THE LATEST EDITION OF THE 9. SINGLE STATION SMOKE/CO2 DETECTORS SHALL BE INSTALLED AT CEILINGS BETWEEN BEDROOMS AND REMAINDER OF THE LANEWAY SUITE AS SHOWN ON DRAWINGS. DETECTORS SHALL BE ULC LABELED.
 - 10. PROVIDE AND INSTALL ALL PLUMBING DISTRIBUTION AND ROUGH-INS AS INDICATED ON ARCH/MECHANICAL DRAWINGS ACCORDING TO LOCAL PLUMBING CODES.
 - 11. PROVIDE AND INSTALL ELECTRICAL/MECHANICAL ITEMS AS INDICATED ON THE ARCHITECTURAL/MECHANICAL DRAWINGS IN ACCORDANCE WITH LOCAL ELECTRICAL AND MECHANICAL CODES.
 - 12. ALL DIMENSIONS TO BE SITE VERIFIED.
 - 13. CONTRACTOR TO CONFIRM SOIL BEARING CAPACITY PRIOR TO CONSTRUCTION.
 - 14. WHERE PLUMBING FIXTURES ABUT AN EXTERIOR WALL, ROUTE SUPPLY AND DRAIN LINES WITHIN THE INTERIOR FACE OF THE INSULATED CAVITY. PROVIDE STRAPPING OR DRAIN CONNECTIONS TO AN INTERIOR PARTITION AS REQUIRED.
 - 15. PROVIDE INSULATION AS PER OBC 12.3.4.5. AND PROTECTION ON SERVICE CONNECTIONS ENTERING THE BUILDING BELOW GRADE AND WITHIN A 4'-0" RADIUS OF EXPOSED GRADE.

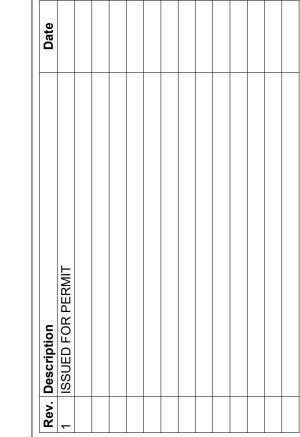

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- THE GENERAL CONTRACTOR SHAI
- CONSTRUCTION, UNLESS IT HAS BEEN



LANESCAPE ARCHITECTURE INC. 282 RICHMOND ST E., SUITE 200 TORONTO, ON M5A 1P4 416 414 9944 x 0

SUITE

ARDEN

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ERMIT OR SSUE

DRAWN CHECKED SCALE As indicated DATE JOB NO

SHEET

ASSEMBLIES SCHEDULE

WALLS/PARTITIONS



TYPE W2c- INSULATED EXTERIOR WALL (1/2" CLADDING): 10" ASSEMBLY EW2c - 0.75 HR FRR [OBC MMAH SB-12 - TABLE 1: FIRE AND SOUND RESISTANCE OF WALLS]

C4 - R22+7.5CI MIN [SB-12 TABLE 3.1.1.2.C (IP)] 1/2" CLADDING - REFER TO ELEVATIONS/CLADDING SCHEDULE

1" x 3" STRAPPING @ 16" O/C 2" (R8CI) ROCKWOOL COMFORTBOARD 80 INSULATION DUPONT TYVEK COMMERCIAL WRAP WEATHER BARRIER 5/8" DENSGLASS GOLD EXTERIOR SHEATHING, ALL JOINTS TAPED AND SEALED W/ PROCLIMA TESCON VANA SHEATHING TAPE

2" x 6" WOOD STUDS @ 16" O/C 5 1/2" (R22) ROCKWOOL COMFORTBATT INSULATION CERTAINTEED MEMBRAIN VAPOUR RETARDER 5/8" TYPE "X" GYPSUM WALL BOARD FINISH



TYPE P1 - TYPICAL INTERIOR PARTITION (4 1/2")

2" x 4" WOOD STUDS @ 16" O/C 1/2" GYPSUM WALL BOARD ON BOTH SIDES



TYPE P5 - TYPICAL INTERIOR PARTITION (6 1/2")

2" x 6" WOOD STUDS @ 16" O/C

1/2" GYPSUM WALL BOARD ON BOTH SIDES



TYPE P5 - TYPICAL INTERIOR PARTITION (8 1/4")

2" x 8" WOOD STUDS @ 16" O/C 1/2" GYPSUM WALL BOARD ON BOTH SIDES

FLOORS AND ROOF

TYPE F2 - CONCRETE SLAB ON-GRADE W/ HYDRONIC RADIANT (1'-0") - R20 MIN.



FLOOR FINISH TO BE SELECTED BY CLIENT ON UNDERLAYMENT AS PER MANUFACTURER'S SPECIFICATIONS 4" CONCRETE SLAB - 32 MPa @ 28 DAYS, 5% - 8% AIR ENTRAINMENT - TROWEL FINISH, WWM REINFORCING IN CENTRE OF SLAB

C/W HYDRONIC RADIANT FLOOR HEAT; REFER TO MECH DWGS 15 MIL POLY VAPOUR BARRIER 2 LAYERS OF 2" (R10) XPS INSULATION; STAGGER SEAMS AND TAPE 4" MIN. COMPACTED FREE DRAINING GRANULAR ON UNDISTURBED SOIL



TYPE F3 - TYPICAL ASSEMBLY FLOOR (VARIES)



FLOOR FINISH TO BE SELECTED BY CLIENT ON UNDERLAYMENT AS PER MANUFACTURER'S SPECIFICATIONS 3/4" T&G PLYWOOD SUBFLOORING, GLUED & SCREWED FLOOR JOISTS (REFER TO FRAMING NOTES) 1/2" GYPSUM WALL BOARD FINISH; TAPE AND SEAL JOINTS



TYPE R3 - INSULATED STANDING SEAM SLOPED ROOF ASSEMBLY (VARIES)
A5 - R31 MIN [SB-12 TABLE 3.1.1.2.A (IP)] / C4 - R31 MIN [SB-12 TABLE 3.1.1.2.C (IP)]




AGWAY METALS NS-25 PROFILE METAL STANDING SEAM CLADDING - 19.5" PANEL, MANUFACTURER'S SHOP FINISH - FINAL COLOUR TBD

ICE & WATER SHIELD ROOFING UNDERLAYMENT 1/2" EXTERIOR GRADE PLYWOOD SHEATHING VENTILATED AIR SPACE; 2" x 3" FURRING @ 16" O/C

DUPONT TYVEK COMMERCIAL WRAP WEATHER BARRIER 5/8" T&G PLYWOOD SHEATHING; ALL JOINTS TAPED AND SEALED W/ PROCLIMA TESCON VANA SHEATHING TAPE ROOF JOISTS (REFER TO FRAMING NOTES)

4" (R20) SPRAY APPLIED CLOSED CELL MEDIUM DENSITY POLYURETHANE FOAM INSULATION FILL CAVITY W/ ROCKWOOL COMFORTBATT (R11 MIN.). ENSURE NO AIR SPACE IN ASSEMBLY 1/2" GYPSUM WALL BOARD FINISH; TAPE AND SEAL JOINTS (NOTE: NO INTERIOR VAPOUR RETARDER IN THIS ASSEMBLY)

ASSEMBLY TAGS

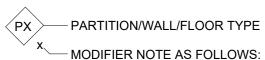

- 'x' = SUBSTITUTE 5/8" TYPE-X GYPSUM BOARD WITH 1/2" GYPSUM WALL BOARD
- 'i' = CAVITY TO RECEIVE SAFE 'N' SOUND ACOUSTIC INSULATION

ACCEPTABLE PRODUCTS

FLAT ROOF MEMBRANE	2 PLY TORCH-LAY ROOFING MEMBRANE, 3/16" IKO PROTECTION BOARD & BASE SHEET
FLEXIBLE FLASHING MEMBRANE	HENRY BLUESKIN WB
FOUNDATION WATERPROOFING	HENRY BLUESKIN WP200
ROUGH OPENING MEMBRANE	 PROCLIMA EXTOSEAL ENCORS SIGA WIGLUV
SHEATHING TAPE	SIGA WIGLUV PROCLIMA TESCON VANA
VAPOUR RETARDER	CERTAINTEED MEMBRAIN PROCLIMA INTELLO PLUS SMART
VAPOUR RETARDER @ LEDGERS & RIM BOARDS	• 15 mil POLY
WEATHER BARRIER	 DUPONT TYVEK COMMERCIAL WRAP SIGA MAJVEST 200 BLUESKIN VP100

ALL PRODUCTS INSTALLED PER MANUFACTURER'S INSTRUCTIONS W/ MAUFACTURER'S

RECOMMENDED COMPATIBLE TAPES, FASTENERS, ADHESIVES, ETC. ALTERNATIVES MUST BE APPROVED BY THE ARCHITECT IN WRITING, IN ADVANCE

NOTED SUPPLIERS:

SIGA PRODUCTS AVAILIBLE FROM:

PROCLIMA PRODUCTS AVAILABLE FROM:

ECO BUILDING RESOURCES - www.eco-building.ca

475 BUILDING MATERIALS - www.foursevenfive.ca

ASSEMBLY NOTES


- EXTERIOR WALLS WITHIN 1.2M FROM PROPERTY LINE (AS PER OBC 9.10.15.5), PACK RIMBOARD CAVITY W/ FIBERBATT INSULATION AND INSTALL TYPE 'X' GYPSUM WALL BOARD BETWEEN JOISTS
- REPLACE GYPSUM WALL BOARD W/ MOULD RESISTANT WALL BOARD @ WET SIDE OF W/C LOCATIONS AND CEMENT BOARD @ TILE LOCATIONS
- 3. ALL PRODUCTS TO BE INSTALLED AS PER MANUFACTURER'S SPECIFICATIONS
- ACCEPTABLE SUBSTITUTIONS:
 - 5/8" DENSGLASS GOLD EXTERIOR SHEATHING SUBSTITUTED WITH 5/8" EXTERIOR GRADE PLYWOOD SHEATHING (ORIENTED STRAND BOARD IS **NOT** AN APPROVED SUBSTITUTE)


ABBREVIATION LEGEND

AD	DKEVIATION LI	LGLI	שו		
A/C AB	AIR CONDITIONING AIR BARRIER	FURN GALV	FURNACE GALVANIZED	RM RTS	ROOM REFER TO SCHEDULE
ABV	ABOVE	GS	GARDEN SUITE	RWL	RAINWATER LEADER
AFF	ABOVE FINISH FLOOR	GYP	GYPSUM	SA	SUPPLY AIR
AHU	AIR HANDLING UNIT	H.P.	HEAT PUMP	SAN	SANITARY
ALUM	ALUMINUM	H/P	HIGH POINT	SCHED.	SCHEDULE
ANOD	ANODIZED	HB	HOSE BIB	SHTG	SHEATHING
AP	ACCESS PANEL	HORIZ	HORIZONTAL	SIM	SIMILAR
APPROX	APPROXIMATELY	HRV	HEAT RECOVERY VENTILATOR	SL	STEEL LINTEL
ARB	ARBORIST	HSS	HOLLOW STRUCTURAL STEEL	SP	SOIL PIPE
AS	AIR SEAL	HW	HIGH WALL	SPEC	SPECIFICATION
AVG	AVERAGE	HWH	HOT WATER HEATER	SPF	SPRAY FOAM
BH	BULKHEAD	HWT	HOT WATER TANK	SS	STAINLESS STEEL
BLDG	BUILDING	ICF	INSULATING CONCRETE FORM	STL	STEEL
BLW	BELOW	INS	INSULATION	STRUC	STRUCTURAL
BSMT	BASEMENT	INT	INTERIOR	SW	SHEAR WALL
C/L	CENTER LINE	JB	JUNCTION BOX	T&G	TONGUE AND GROOVE
C/W	COMPLETE WITH	L/P	LOW POINT	T&P	TRENCH & POUR
CAB	CABINET	LAV	LAVATORY	T/O	TOP OF
CAD	CANTILEVER	LBW	LOAD BEARING WALL	TBC	TO BE CONFIRMED
CB	CEMENT BOARD	LD	LIMITING DISTANCE	TBD	TO BE DETERMINED
CC	CLOSED CELL	LDGR	LEDGER	TPH	TREE PROTECTION HOARDING
CIP	CAST IN PLACE	LW	LOW WALL	TPZ	TREE PROTECTION ZONE
CL.	CLOSET	LWS	LANEWAY SUITE	TYP.	TYPICAL
CLG	CEILING	M/P	MID POINT	U/S	UNDER SIDE
CONC	CONCRETE	MAX	MAXIMUM	UF	URBAN FORESTRY
COND	CONDITIONS	MECH	MECHANICAL	UNF	UNFINISHED
CONT	CONTINUOUS/CONTINUE	MFG	MANUFACTURER	VENT	VENTILATED
CS	COUNTERSUNK	MH	MAIN HOUSE	VERT	VERTICAL
DET	DETAIL	MIN	MINIMUM	VR	VAPOUR RETARDER
DIA	DIAMETER	MTD	MOUNTED	W/C	WATER CLOSET
DIM	DIMENSION	NOM	NOMINAL	WB	WEATHER BARRIER
DRN	DRAIN	NTS	NOT TO SCALE	WIC	WALK IN CLOSET
DWG	DRAWING	O/C	ON CENTER	WP	WATERPROOF
E/O	EDGE OF	O/H	OVERHANG	WWM	WELDED WIRE MESH
EF	EXHAUST FAN	OD	OUTSIDE DIAMETER	XPS	EXTRUDED POLYSTYRENE
ELEC	ELECTRICAL	OPNG	OPENING	/ / /	EXTRODED FOR THEME
ELEV	ELEVATION	OPP	OPPOSITE		
ENC	ENCLOSURE	OTA	OPEN TO ABOVE		
ENS	ENSUITE	ОТВ	OPEN TO BELOW		
EP	ELECTRICAL PANEL	PA	POST ABOVE		
EPS	EXPANDED POLYSTYRENE	P/R	POWDER ROOM		
EPX	EPOXY	PERP	PERPENDICULAR		
ERV	ENERGY RECOVERY VENTILATOR	PF	PREFINISHED		
EX	EXISTING	PL	PROPERTY LINE		
EXH	EXHAUST	PLY	PLYWOOD		
EXP	EXPOSED	PT	PRESSURE TREATED		
EXT	EXTERIOR	QTY	QUANTITY		
F/O	FACE OF	R/O	ROUGH OPENING		
FD	FLOOR DRAIN	RA	RETURN AIR		
FFE	FINISH FLOOR ELEVATION	REC	RECESSED		
FND	FOUNDATION	REINF	REINFORCED		
FRR	FIRE RESISTANCE RATING	REQ	REQUIRED		
FTG	FOOTING	REV	REVISION		

OBC MATRIX

ГЕМ					RIO BUILDIN ATA MATRI	NG CODE 201 X PART 9	17								ONTARIO REFERENCE REFERENCES ARE TO DIVISION B UNLESS NOTED [A] FOR DIVISION C OR [C] FOR DIVISION C
1	PROJECT D	DESCRIPTION:		NEV	W CONSTRUC	TION									PART 9
				— ADI	DITION										1.1.2.[A]
			CHAN	GE OF USE ALT	ERATION - IN	TERIOR									
2	MAJOR OC	CUPANCY(S)		GROUP	С	DIV. N/A									9.10.2.
3	BUILDING A	AREA (m²)		PROPOS	ED:	0.00 m²	_								1.4.1.2.[A]
la	GROSS FLO	OOR AREA (m²)		GROUND	LEVEL:	0.00 m²	_								1.4.1.2.[A]
				UPPER L	EVEL:	0.00 m²	_								
				TOTAL:		0.00 m²	_								
5	MEZZANINE	E(S) AREA (m²) _!	N/A												9.10.4.1.
6	NUMBER O	F STOREYS	ABOVE GI	RADE 2	BELOW GF	RADE 0									1.4.1.2. [A] & 9.10.4
,	NUMBER O	F STREETS/FIRE	FIGHTER AC	CESS EXISTING (1)											9.10.20
	SPRINKLER	R SYSTEM EXISTI	NG		ENTIRE BUIL	DING									9.10.8.2 4.
					SELECTED C	OMPARTMENT	S								
					SELECTED F	LOOR AREAS									
					BASEMENT	☐ IN LIEU OF	ROOF RAT	ING							
					NOT REQUIR	RED									
)	FIRE ALARI	M REQUIRED			YES N	0									9.10.18.
0	BUILDING (CLASSIFICATION	3.2.	2.46. GROUP C, UP TO 3 S	TOREYS				_						-
1	CONSTRUCTION RESTRICTIONS COMBUSTIBLE NON - COMBUSTIBLE BOTH REQUIRED														9.10.6.
2	ACTUAL CO	ONSTRUCTION		COMBUSTIBLE	NON - COMB	USTIBLE	ВОТН								
3	OCCUPANT	T LOAD BASED OF	N	m²/PERSON	DESIGN OF E	BUILDING	N/A (NC	CHAN	GE)						3.1.17
	GROUN	ID LEVEL:		N/A											
	UPPER			2 PERSONS PER SLEEF	PING AREA*		X PERSO	ONS	_						
						TOTAL:	X PERSO	ONS	_						
	*AS PER	R OBC 3.1.17.1 (b))												
4	BARRIER -	FREE DESIGN		YES NO											9.5.2.& 3.8.1.1.
5	HAZARDOL	JS SUBSTANCES		YES NO											9.10.1.3.
3	REQUIRED	FIRE RESISTANC	E RATINGS												9.10.8.
				HORIZONTAL ASSEMBLY		F.R.R. (HOURS)	SUPPOR ASSEMBL		LISTED DESIGN			COMBUS LIEU OF F.		N/A	
				FLOORS		-			-	-	YES	□ NO			
				MEZZANINE		_					YES	□ NO			
				ROOF		_			_		YES	□ NO			
7	SPATIAL SE	EPARATION - CON	NSTRUCTION	OF EXTERIOR WALLS] .20				9.10.15.
	WALL	EXPOSED BLDG. FACE (m²)	LIMITING DIST.(m)	PERMITED MAX. GLAZED OPNGS IN EBF = (LD) ^{2*}	AREA OF		LISTED DESIGN	R	CONST. REQUIRED		R	CLADDING EQUIRED	**	PROPOSED	
	EAST	25.35	1.53	2.34	2.06	N/A	EW2c		IBUSTIBLE COMBUS			MBUSTIBL -COMBUS		вотн	
	WEST	25.35	6.75	45.56	12.31	N/A	EW2c		BUSTIBLE COMBUST			MBUSTIBL -COMBUS		вотн	
	SOUTH	16.55	2.99	8.94	1.10	N/A	EW2c	COM	IBUSTIBLE COMBUST	E OF	S NON	-COMBUS		вотн	
	NORTH				0	0.75	EW2c	COM	IBUSTIBLE	OR COMBUSTIBLE OR		COMBUSTIBLE OR NON-COMB			1
		19.80 BC 9.10.15.4. (1)(c	0	-		0.73	**AS PER		10 15 5 (2			-COMBUS	TIBLE	. TOTT-OONID.	-
1	WASHROO	M CALCULATION:	S LAVATORIES	+ 2 WATER CLOSETS + 1				0.00	10.10.0. (2	- 10	(1)				

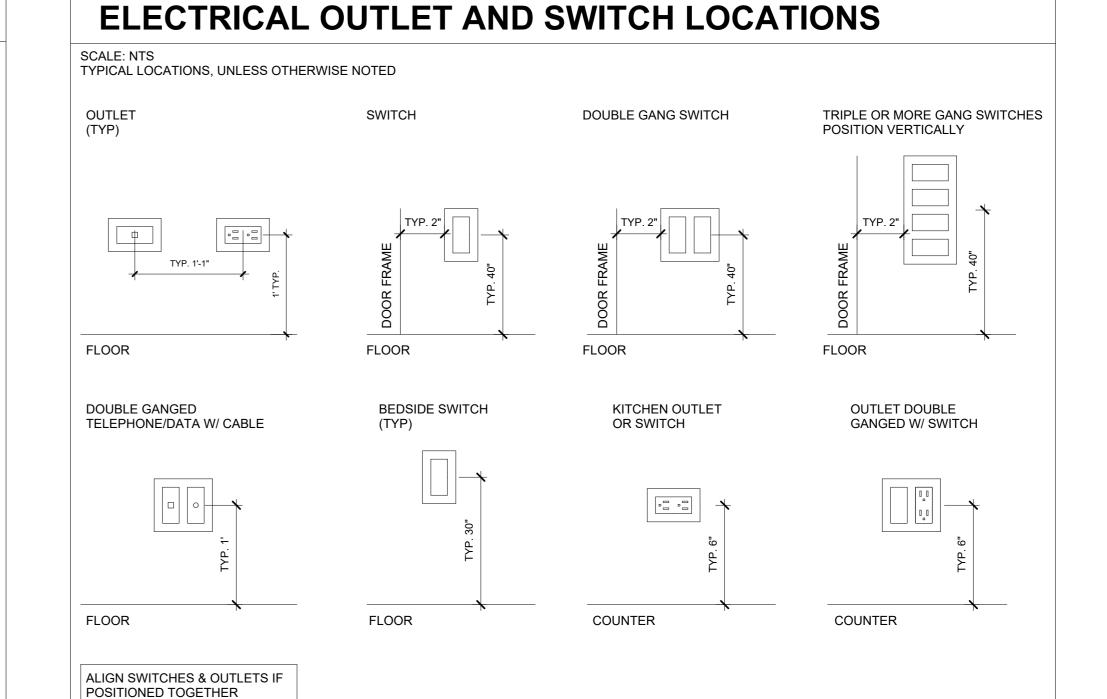

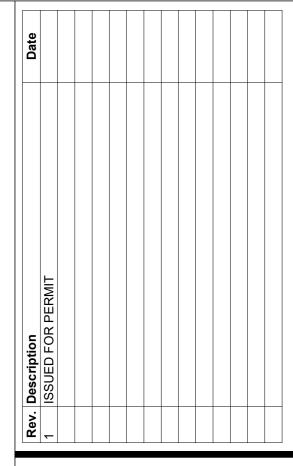

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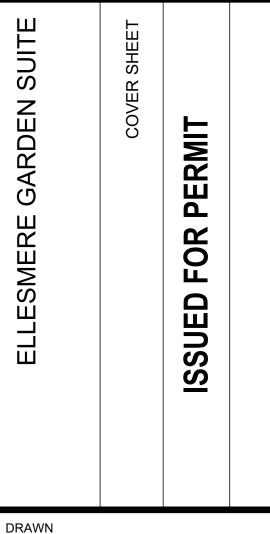
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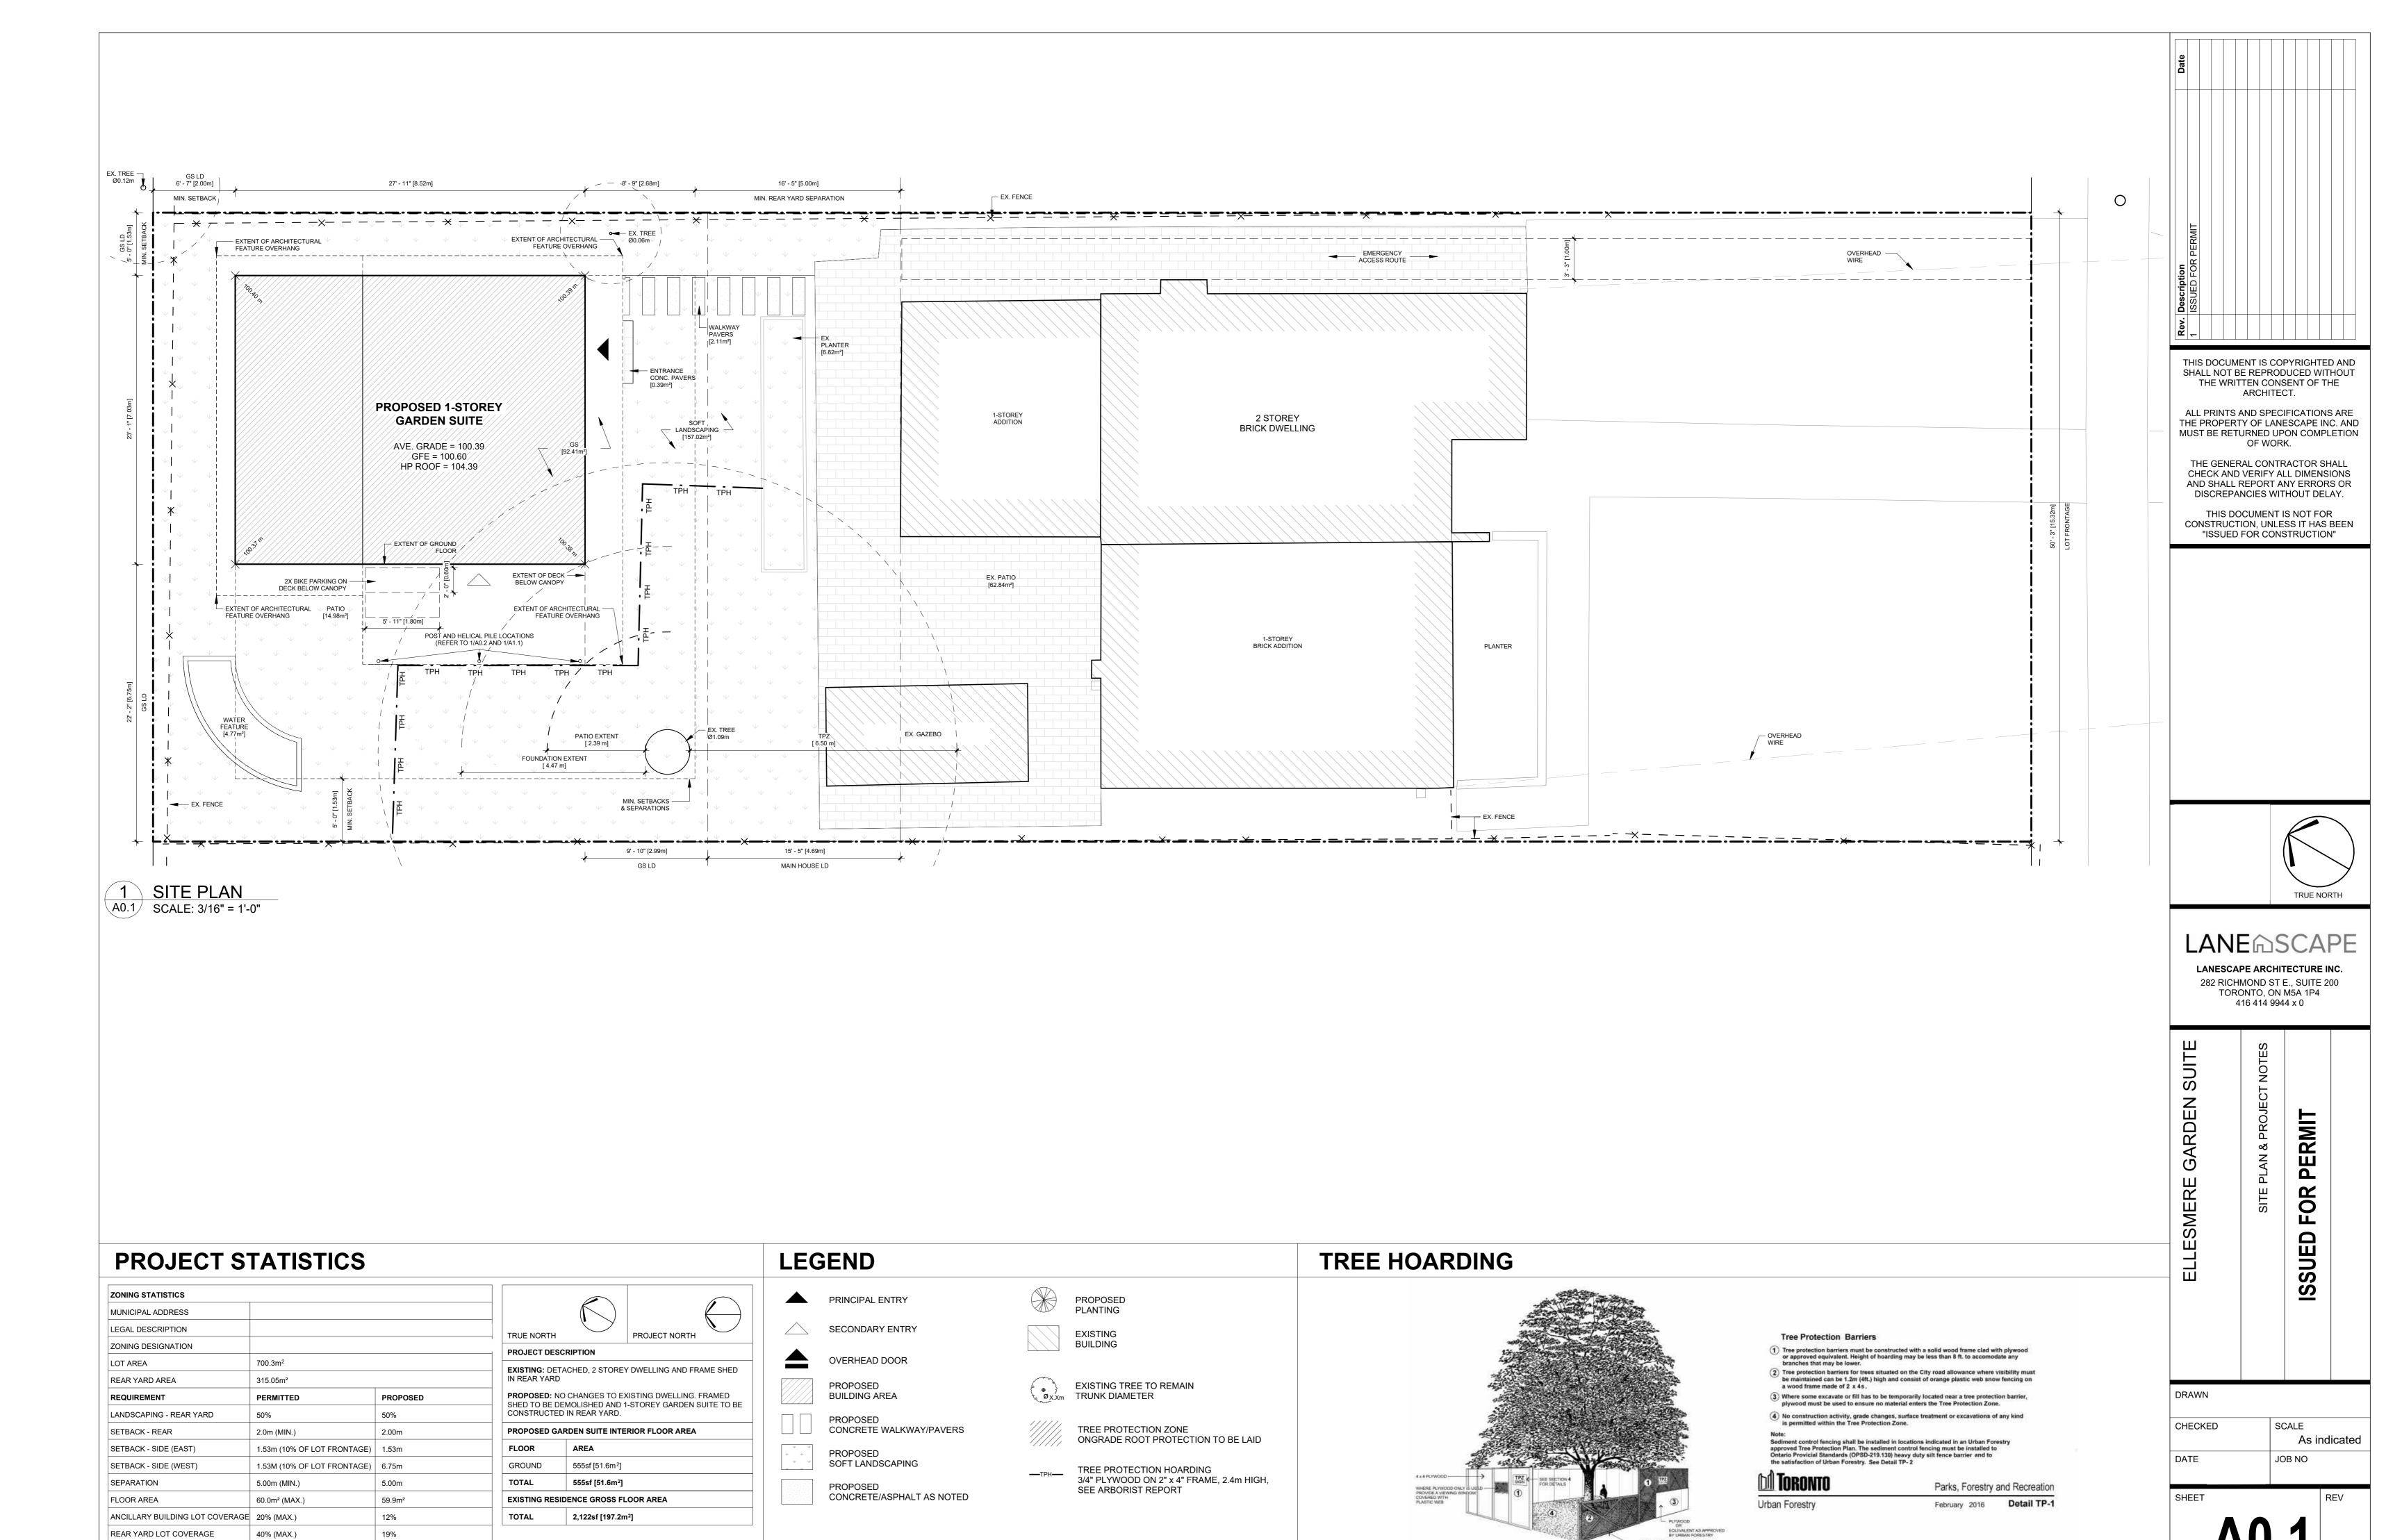
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LANE SCAPE

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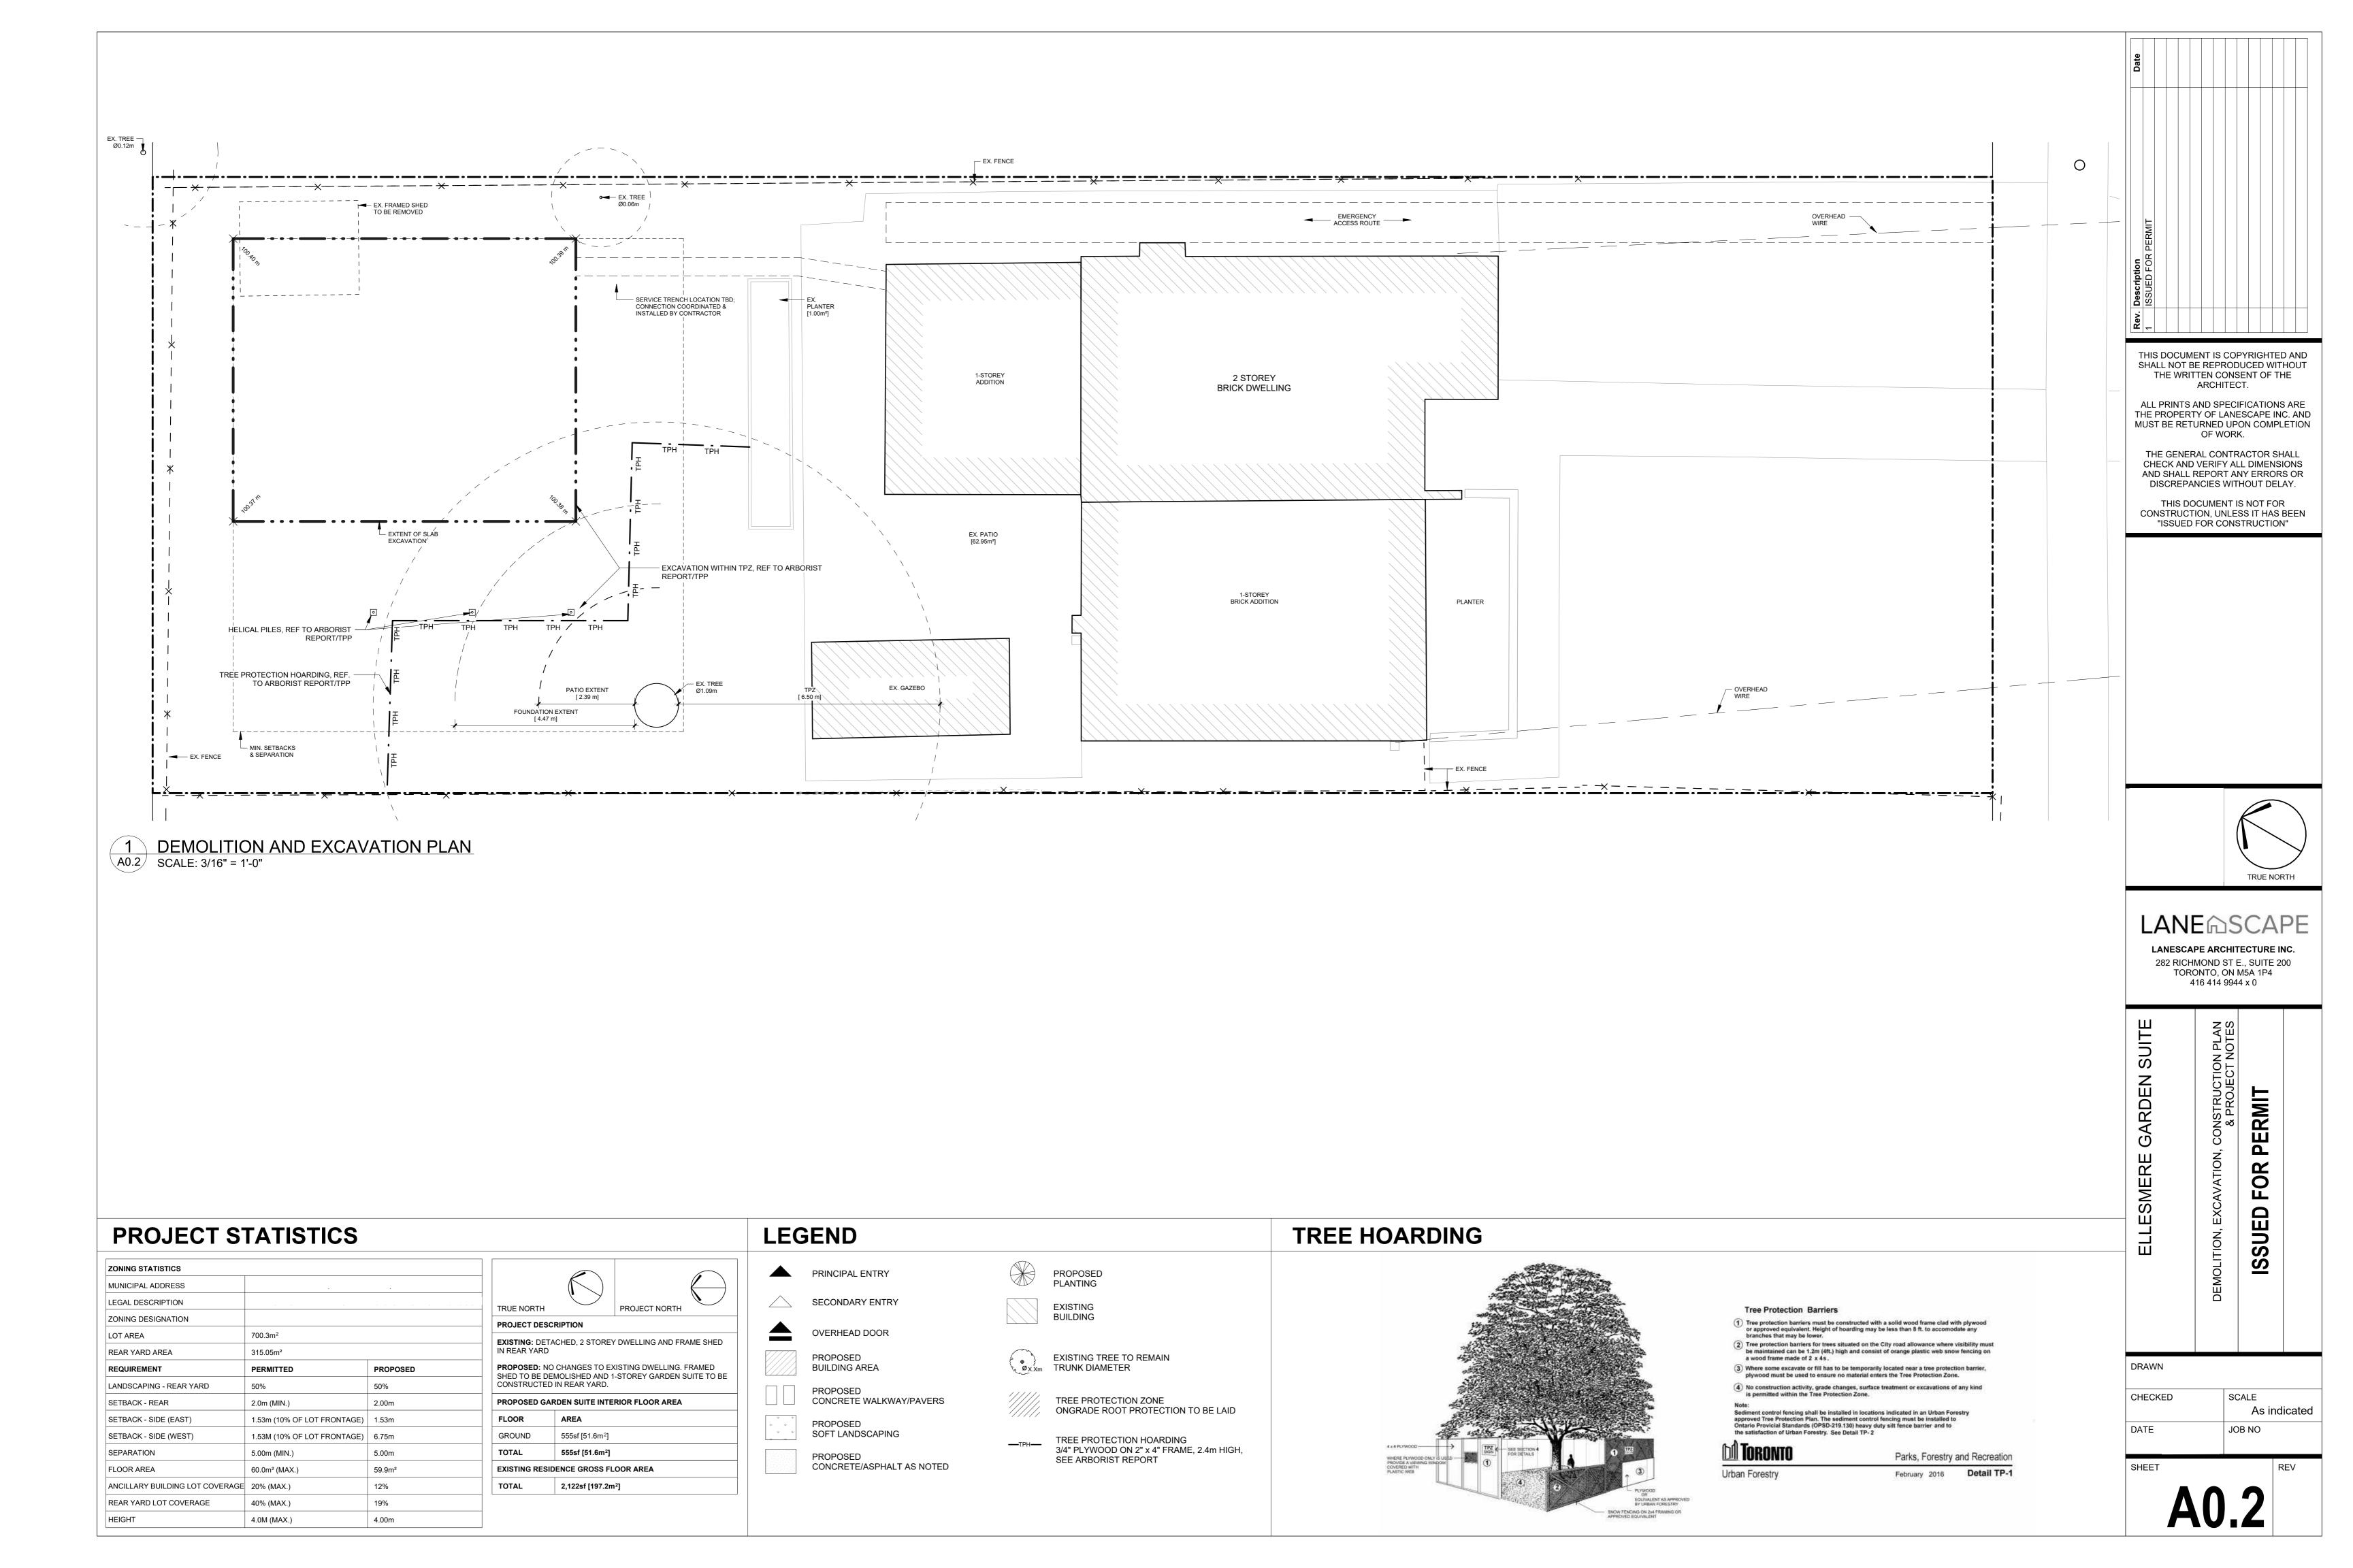



CHECKED SCALE As indicated JOB NO



4.0M (MAX.)

4.00m



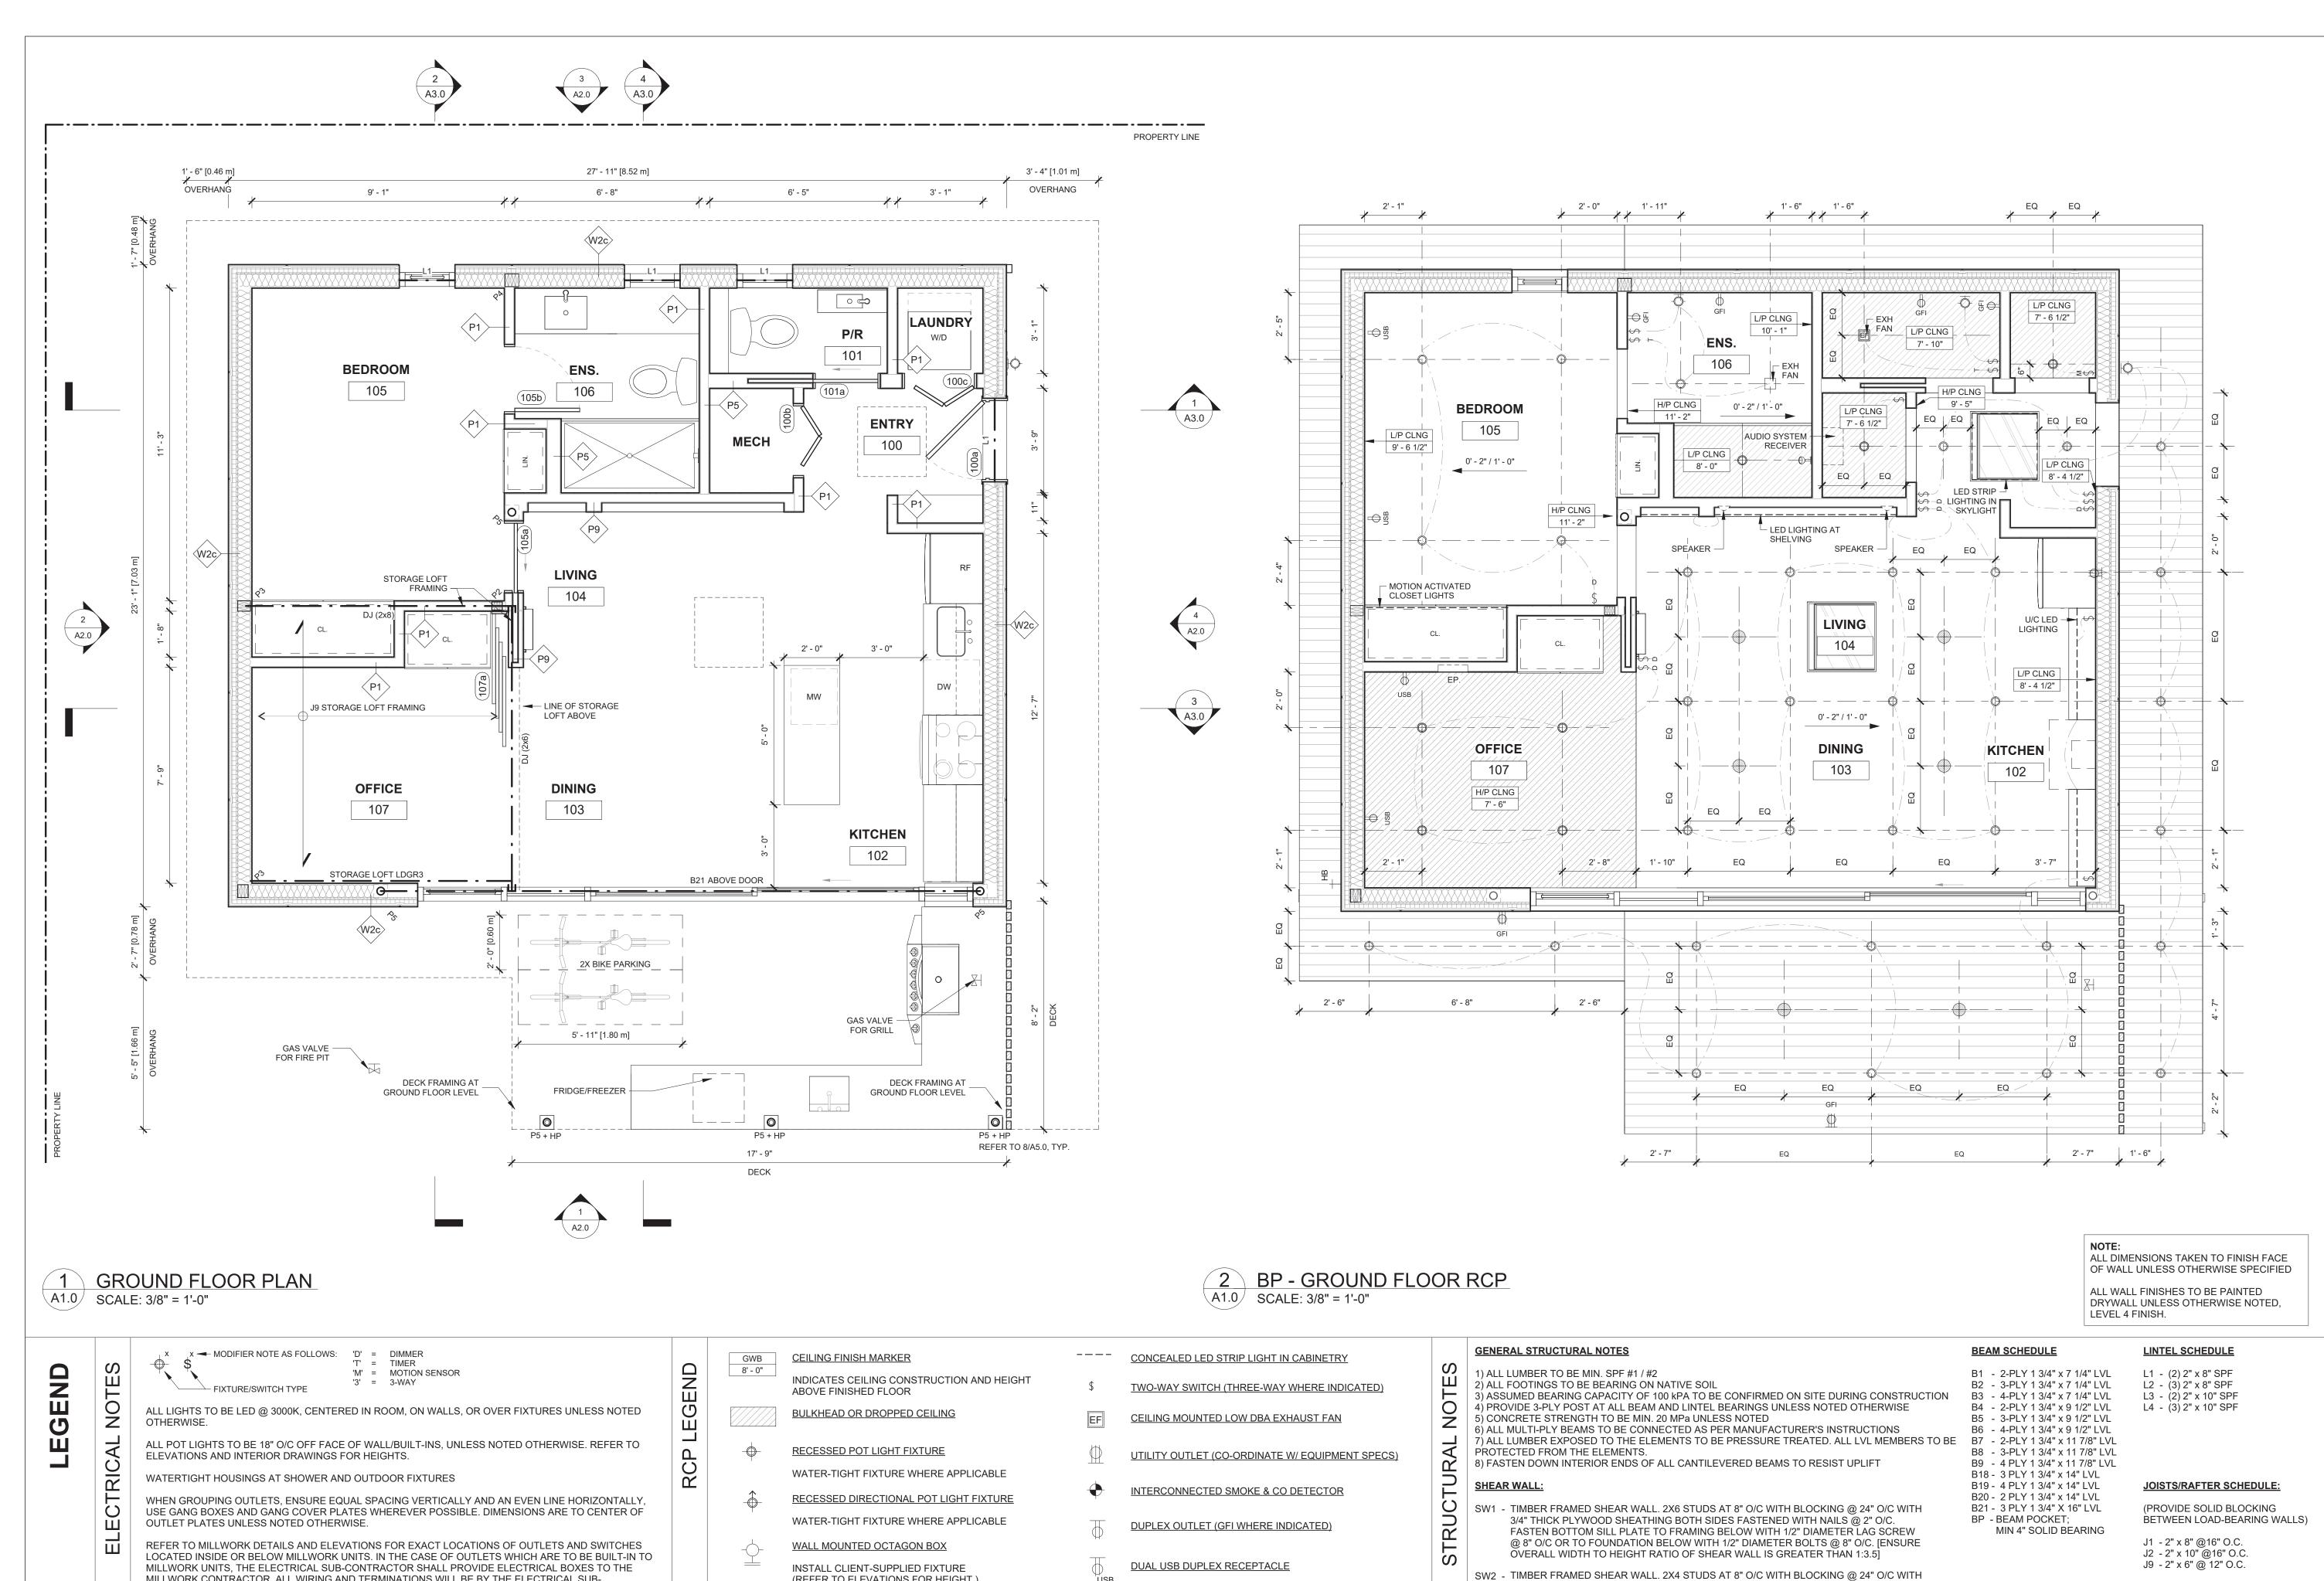

DATA RECEPTACLE

<u>HOSE BIB</u>

(REFER TO ELEVATIONS FOR HEIGHT.)

CEILING MOUNTED OCTAGON BOX

INSTALL CLIENT-SUPPLIED FIXTURE

WATER-TIGHT FIXTURE WHERE APPLICABLE

GAS VALVE

CEILING SPEAKER

MILLWORK CONTRACTOR. ALL WIRING AND TERMINATIONS WILL BE BY THE ELECTRICAL SUB-

REVIEWED AND APPROVED BY THE PROJECT MANAGER IN WRITING.

ADDITION, SUBTRACTION, OR RELOCATION OF LIGHTING, POWER, AND COMMUNICATIONS MUST BE

THE ELECTRICAL SUB-CONTRACTOR IS RESPONSIBLE FOR OBTAINING THE PROJECT MANAGER'S

APPROVAL FOR THE LOCATION OF OUTLETS, SWITCHES, ETC. PRIOR TO THE START OF WORK AT

CONTRACTOR.

COMPLETION OF ROUGH-INS.

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PROJECT NORTH

LANE SCAPE

LANESCAPE ARCHITECTURE INC 282 RICHMOND ST E., SUITE 200 TORONTO, ON M5A 1P4 416 414 9944 x 0

SUITI Ш

RMIT 0 SSU

DRAWN CHECKED

DJ: DOUBLE JOIST

TJ: TRIPLE JOIST

R1 - 2" x 6" @ 16" O.C. R2 - 2" x 8" @ 16" O.C.

R3 - 2" x 10" @ 16" O/C

LDGR1: 2 x 8 PT LEDGER FASTNED

WITH 1/2"ø ANCHOR BOLTS @ 16"

LDGR3: 2 x 6 PT LEDGER FASTNED

WITH (3)-1/4"ø LAG SCREWS @ 16"

O.C. DIRECTLY TO STUDS

POST SCHEDULE

P1 - (3) 2" x 4"

P2 - (4) 2" x 4"

P3 - (3) 2" x 6" P4 - (4) 2" x 6"

P5 - HSS 3 1/2ø x 1/4"

P6 - HSS 4" x 4" x 1/4"

P/A- POST ABOVE

P/B- POST BELOW

w/ 6"x6" x1/4" PLATES

w/ 6" x 6" x 1/4" PLATES

3/4" THICK PLYWOOD SHEATHING BOTH SIDES FASTENED WITH NAILS @ 2" O/C.

OVERALL WIDTH TO HEIGHT RATIO OF SHEAR WALL IS GREATER THAN 1:3.5]

FOOTING SCHEDULE

(ALL FOOTINGS ON UNDISTURBED SOIL; NOT GRAVEL)

F2 - 24" x 24" x 8" FOOTING ON UNDISTURBED SOIL

F3 - 16" X 16" X 8" POURED CONCRETE PAD FOOTING

F1 - 36" x 36" x 12" FOOTING WITH 15M @ 12" O/C EACH WAY


HP - HELICAL PILE FOUNDATION (REF TO SHOP DRAWINGS)


8" O/C OR TO FOUNDATION BELOW WITH 1/2" DIAMETER BOLTS @8" O/C. [ENSURE


FASTEN BOTTOM SILL PLATE TO FRAMING BELOW WITH 1/2" DIAMETER LAG SCREW @


SCALE As indicated DATE JOB NO

SHEET

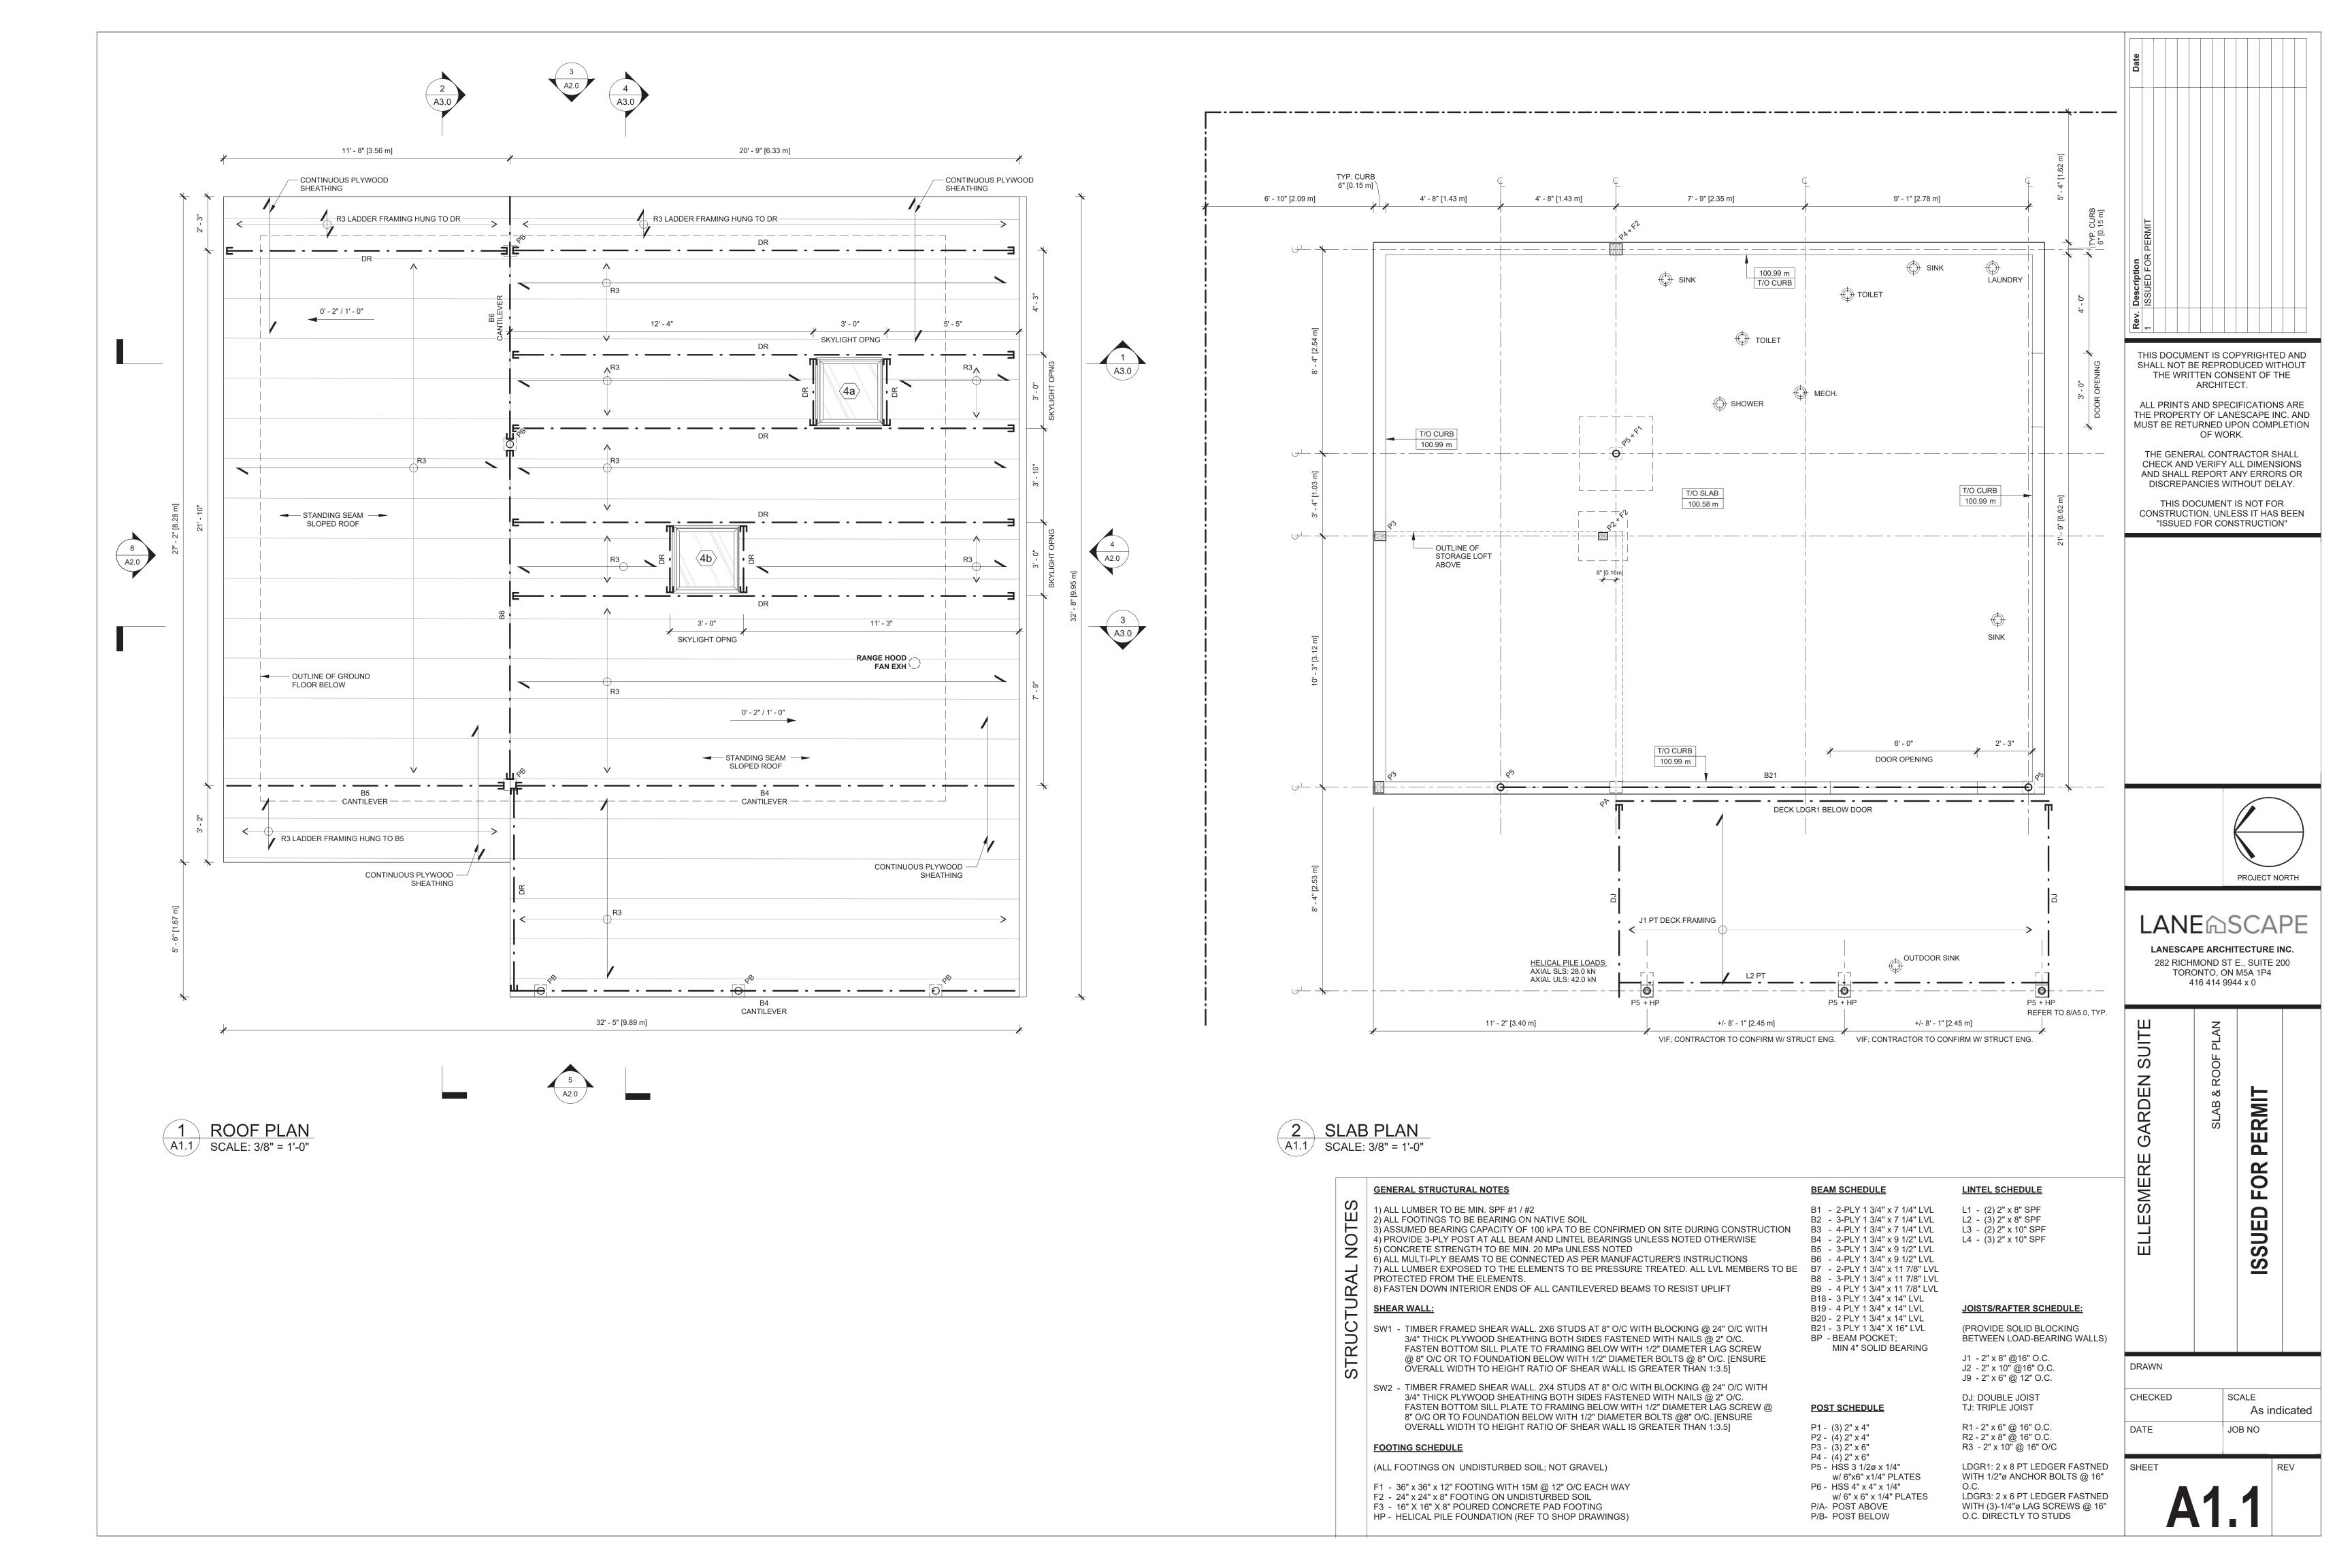


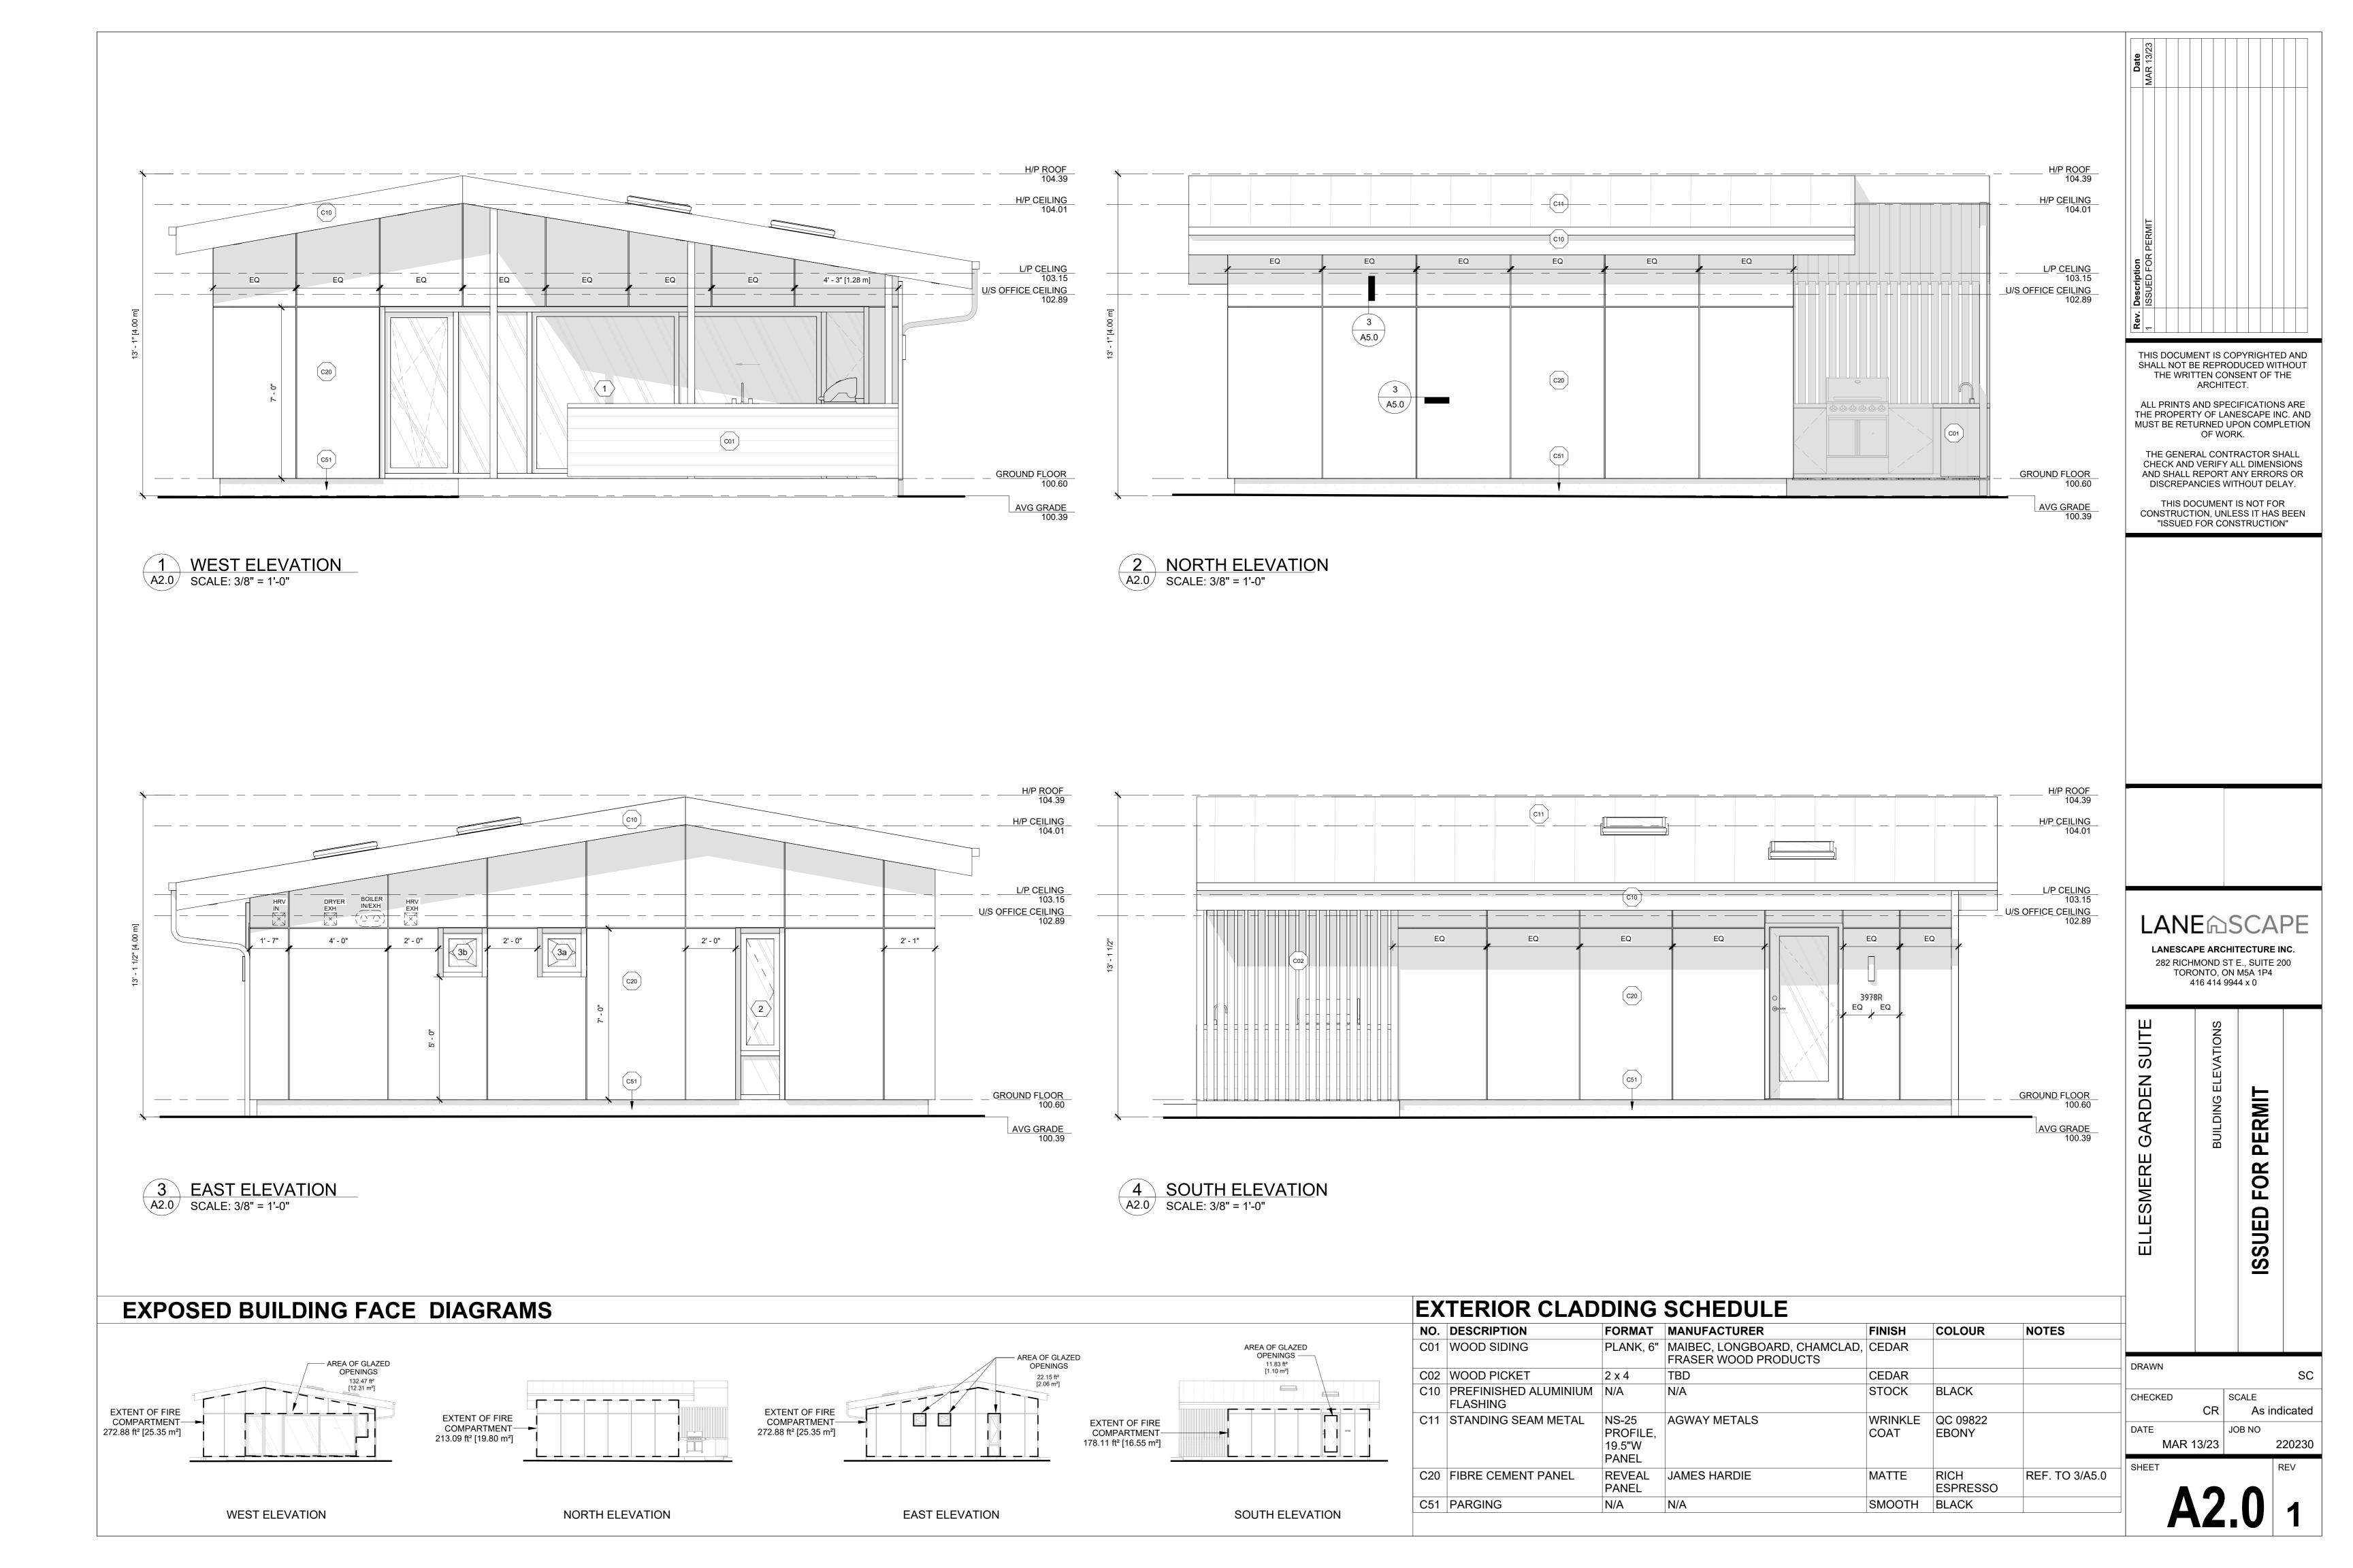

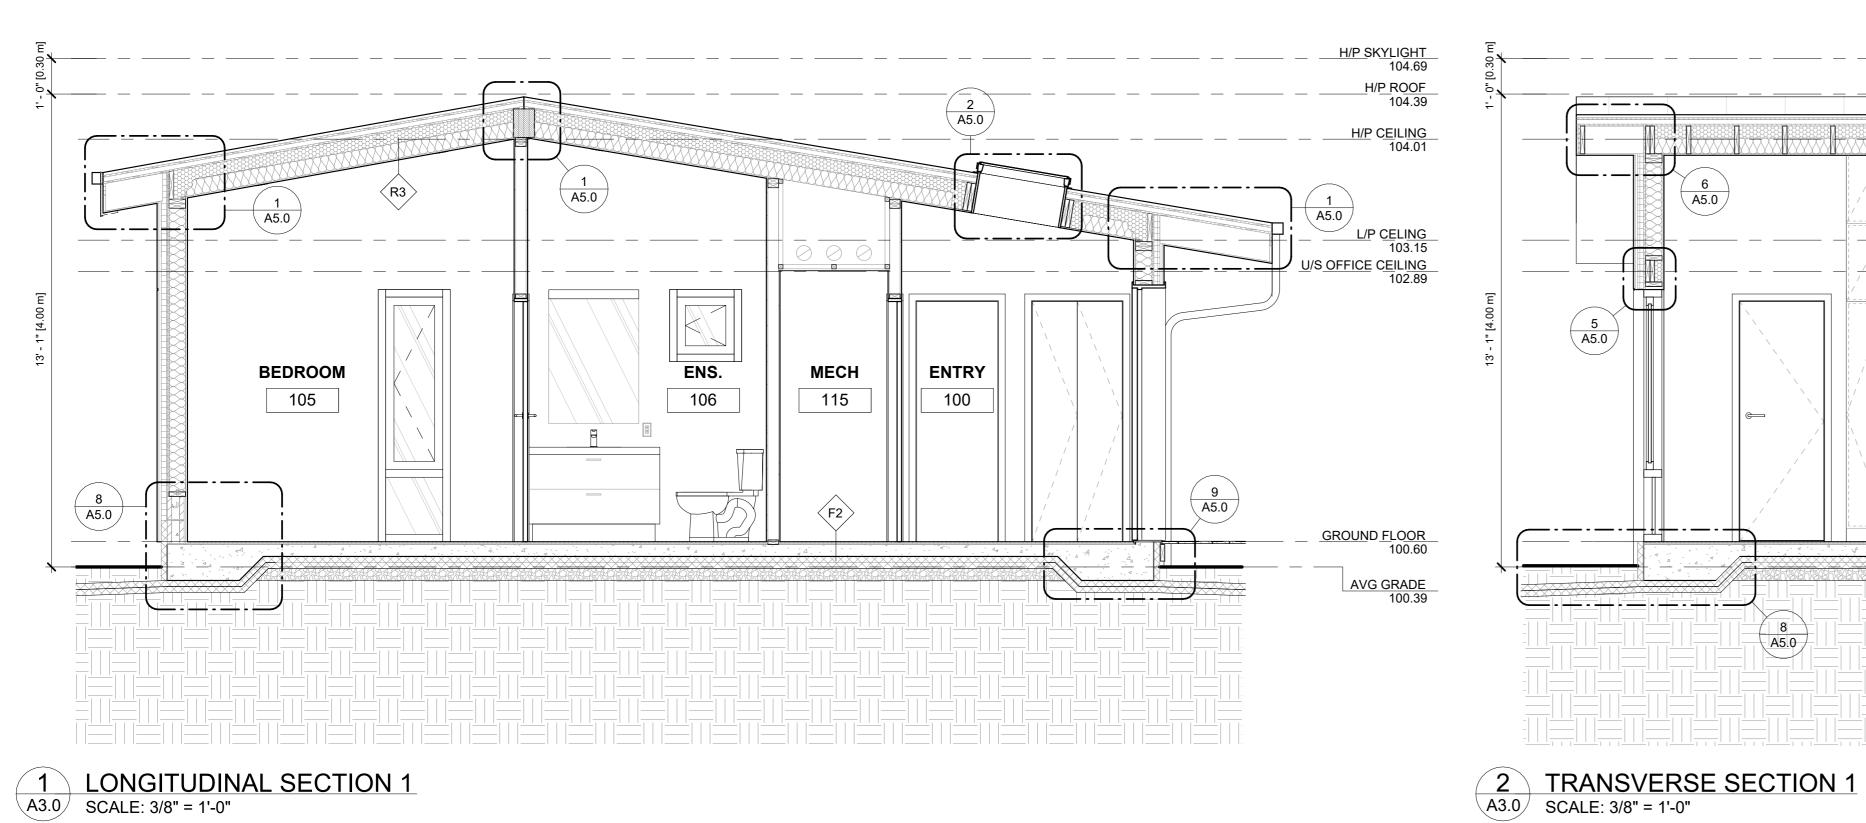

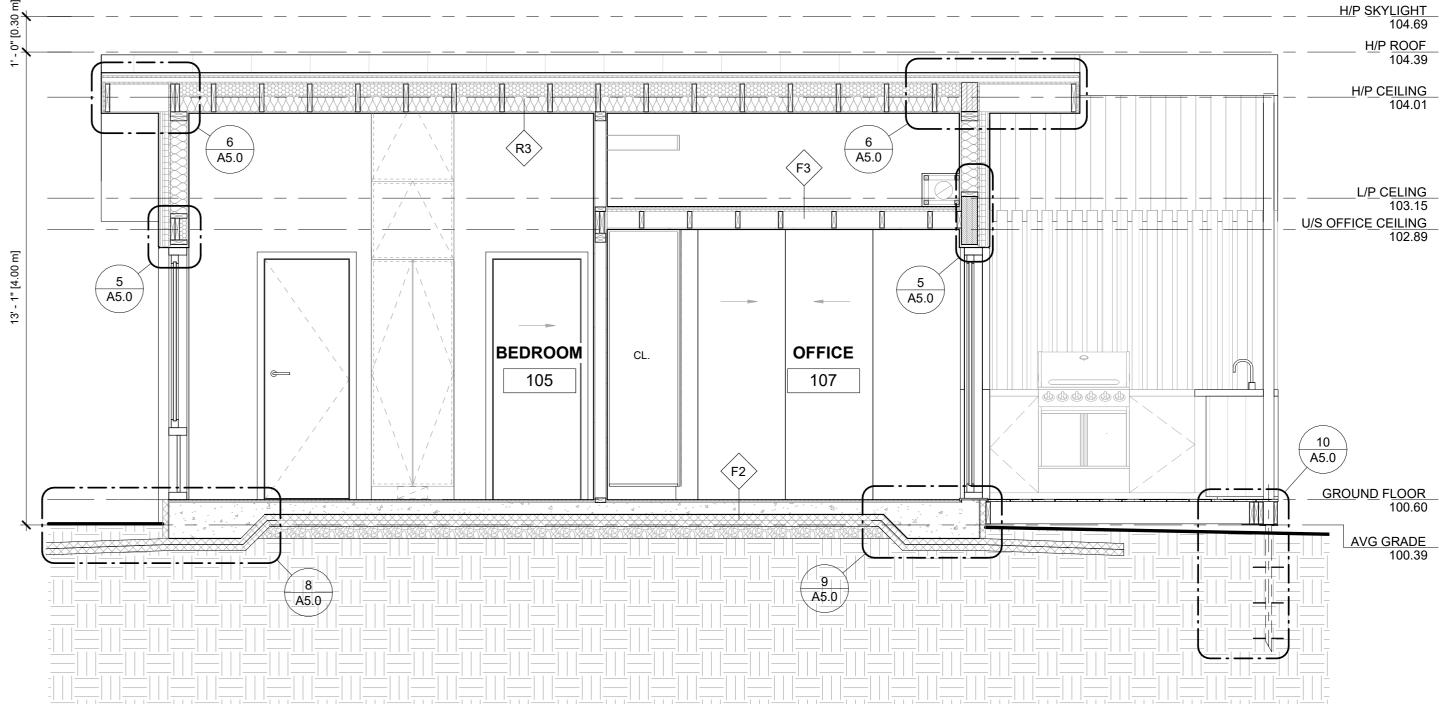

H/P SKYLIGHT 104.69 H/P ROOF 104.39 H/P CEILING 104.01 FUR CEILING DOWN TO ALIGN W/ EDGE OF STORAGE LOFT SUPPLY RUN HEAT PUMP -10" [0.25 m] U/S OFFICE CEILING A5.0 OFFICE KITCHEN DINING 107 103 102 8 A5.0 GROUND FLOOR 100.60

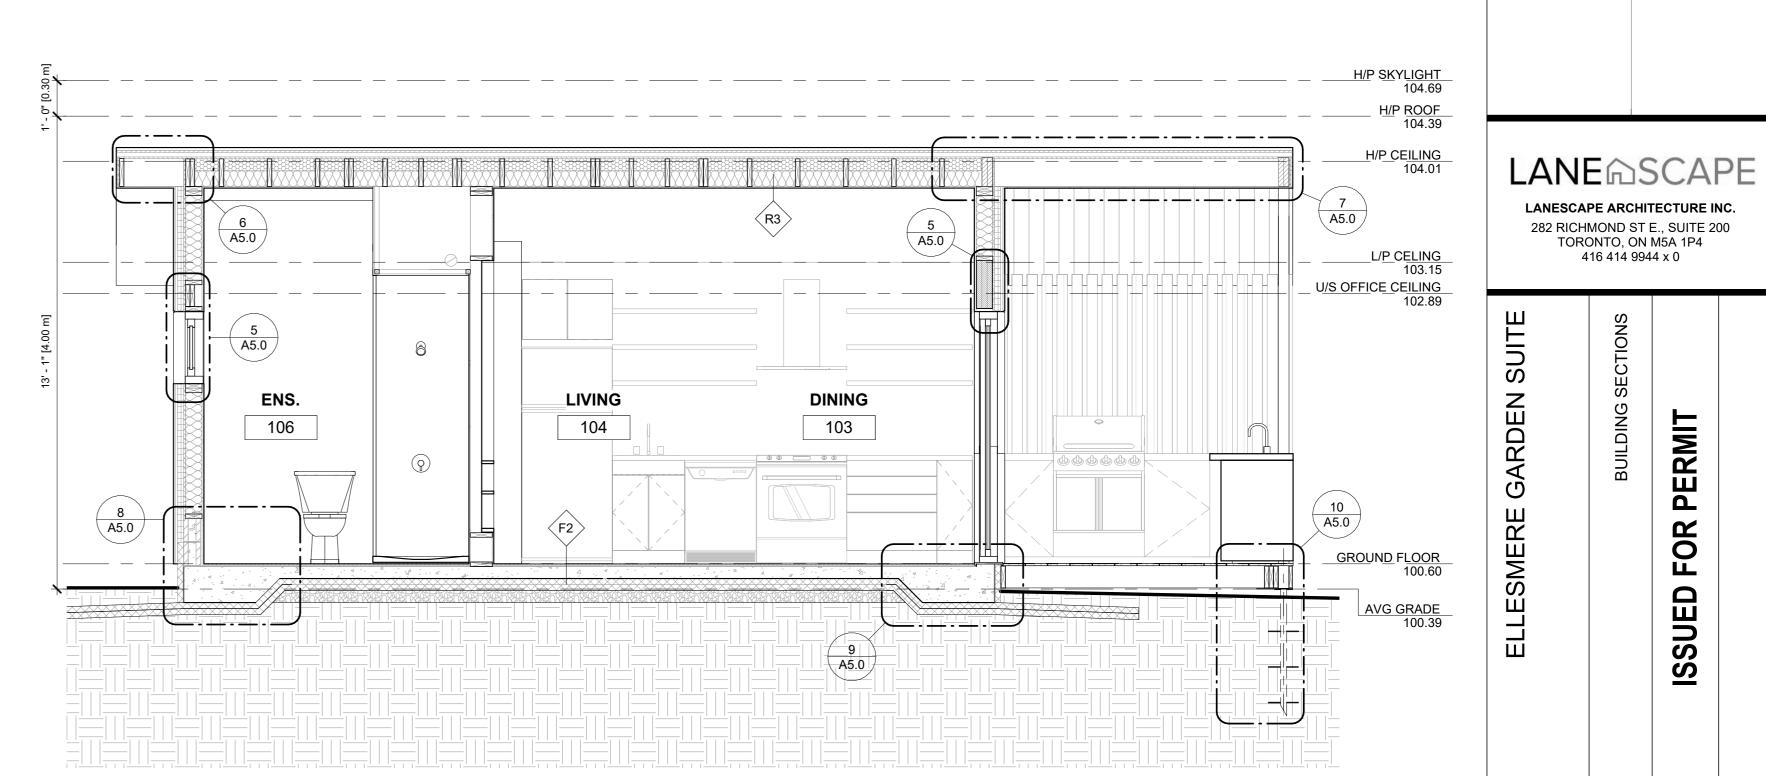

3 LONGITUDINAL SECTION 2
A3.0 SCALE: 3/8" = 1'-0"

4 TRANSVERSE SECTION 2
A3.0 SCALE: 3/8" = 1'-0"

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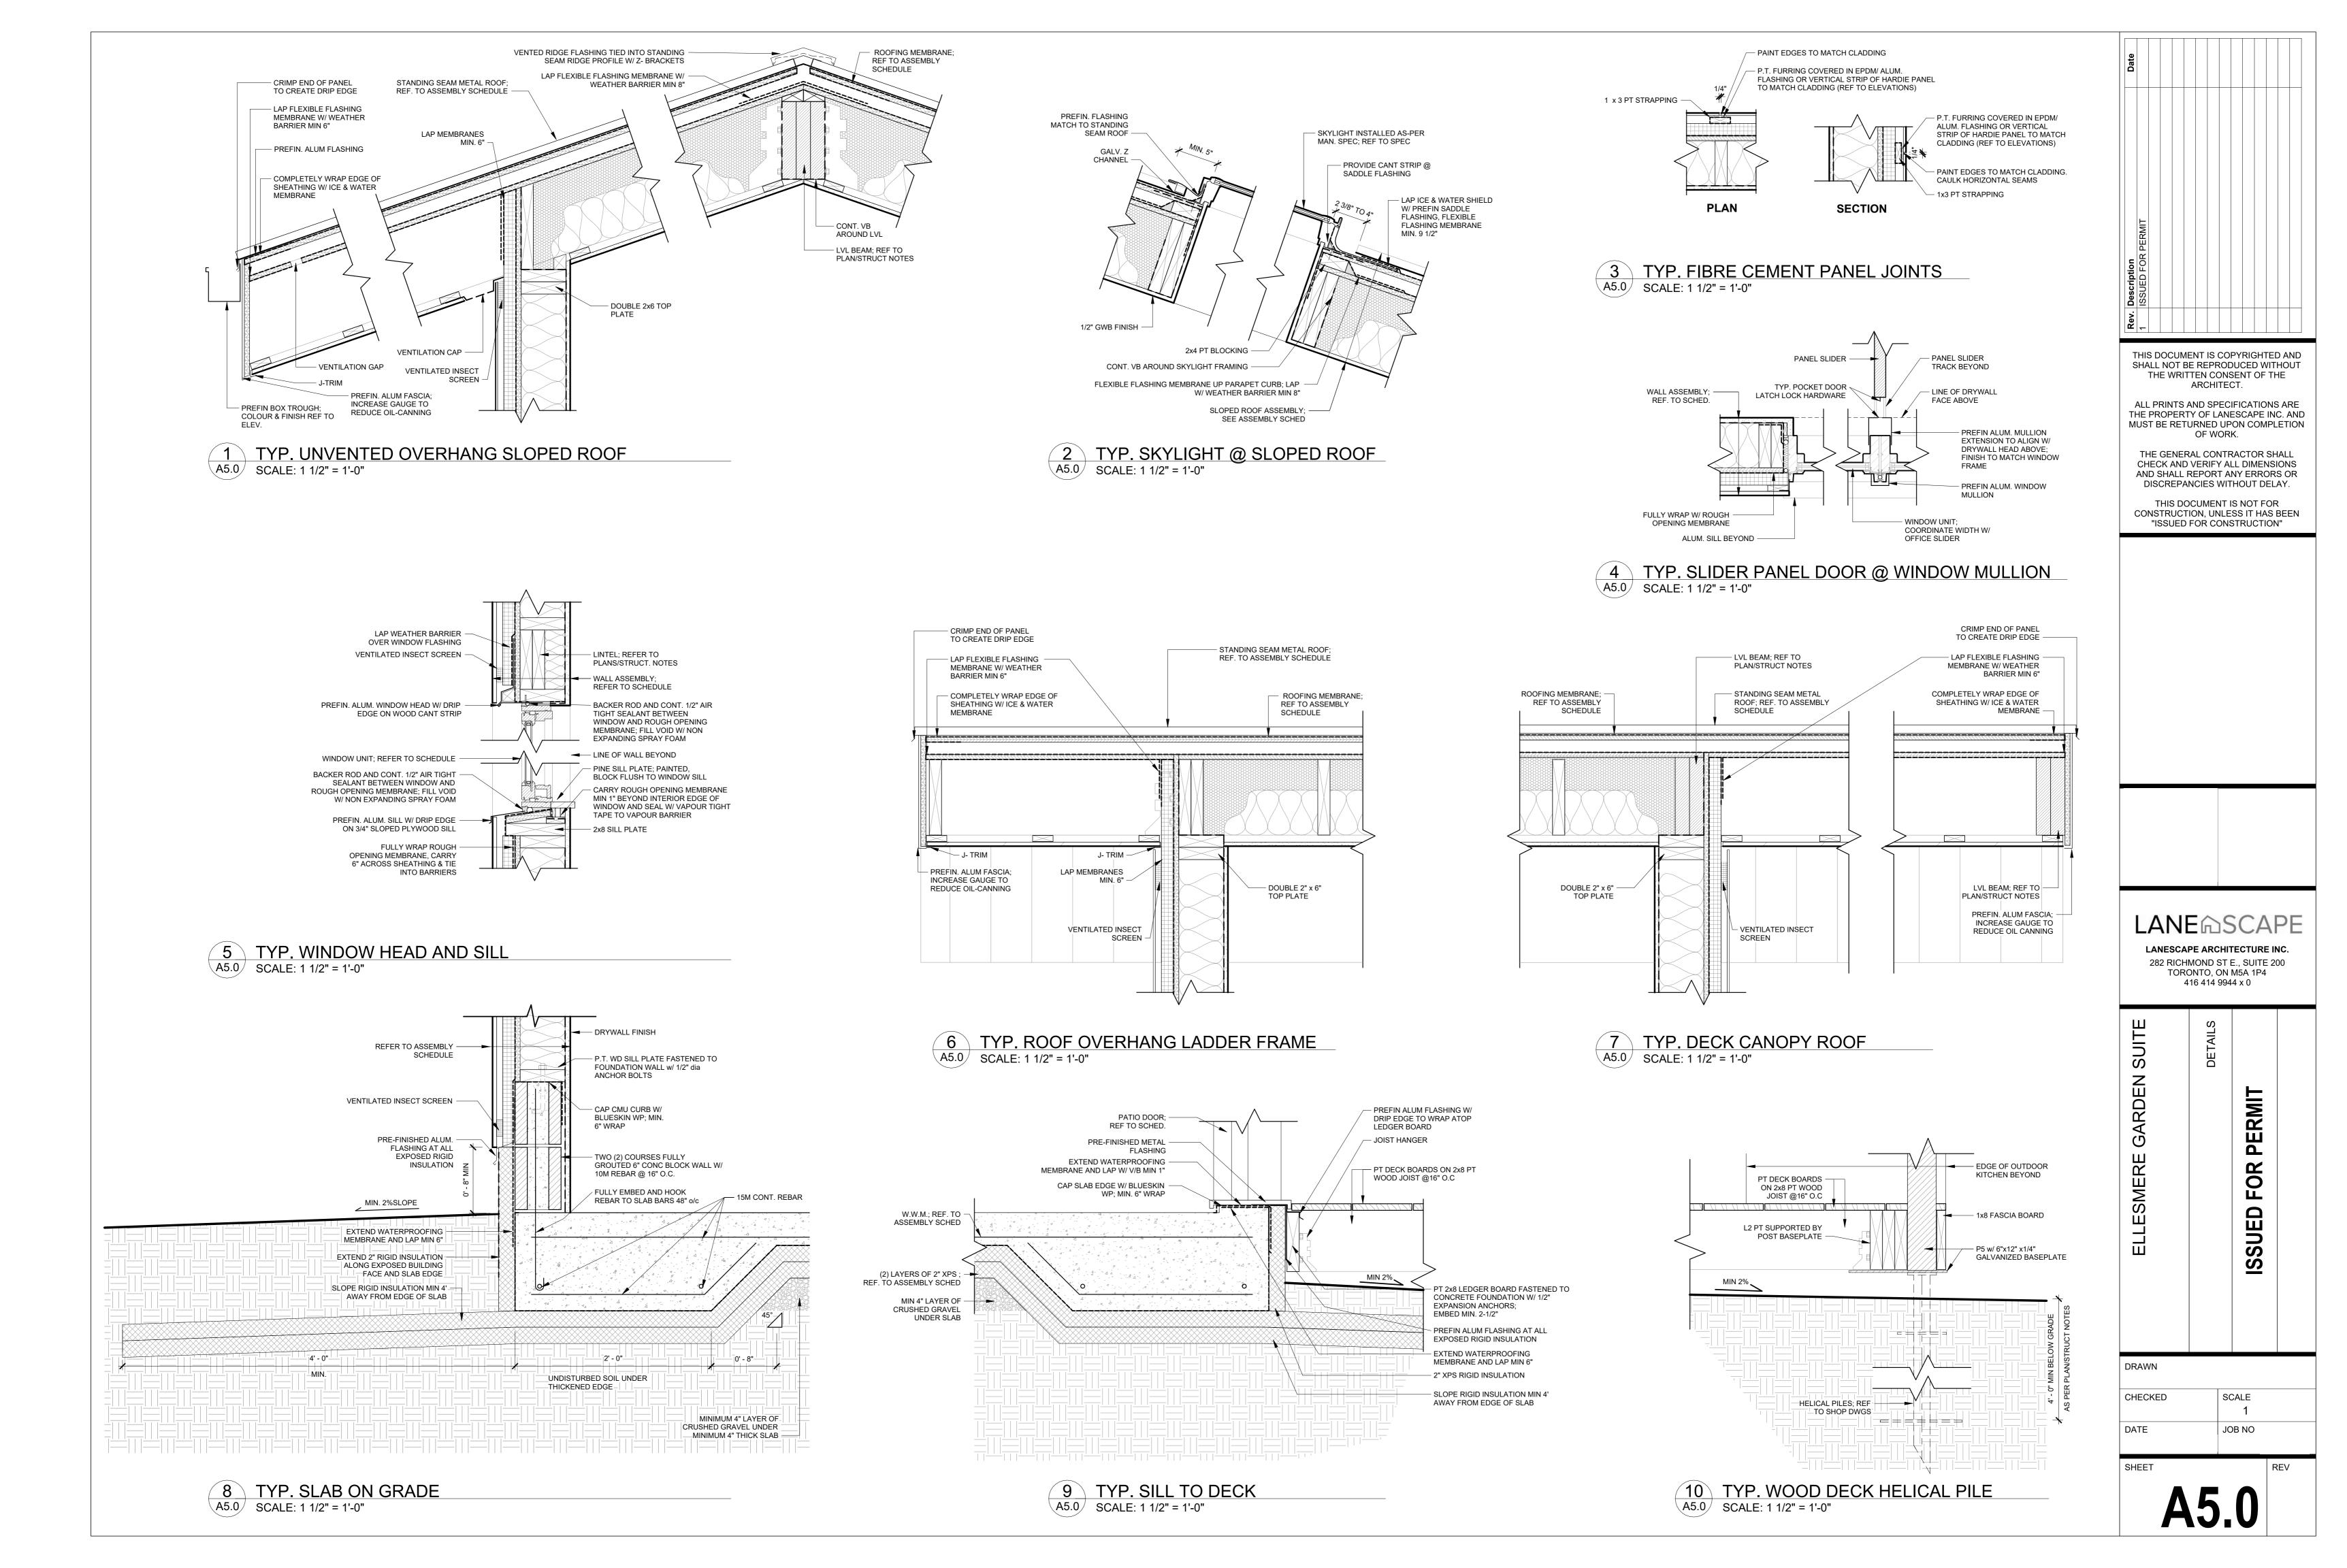
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LANESCAPE ARCHITECTURE INC. 282 RICHMOND ST E., SUITE 200 TORONTO, ON M5A 1P4 416 414 9944 x 0

PERMIT ELLESMERE **ISSUED FOR**

DRAWN CHECKED SCALE DATE JOB NO

SHEET



DOOR / HARDWARE SCHEDULE

LOCATION				DOOR	1					FRAME		HARDWA	RE	REMARKS
ARCH. OPENING NO.	FROM	KEYSIDE	ТО	TYPE	CONSTRUCTION	FINISH	LEAF	F SIZE THICK	NESS FIRE RATII	NG CONSTRUCTION	FINISH	STYLE	FUNCTION	
100a	EXTERIOR	EXTERIOR	ENTRY	Α	INSULATED FIBREGLASS	SHOP	2' - 10" x 7'	' - 0" 1 3/4"	-	INSULATED FIBREGLASS	SHOP	LATCH	KEY OPERATED LOCKSET & DEADBOL	T INSULATED EXTERIOR DOOR AND INSULATED FRAME W/ VISION PANEL
100b	ENTRY	-	MECH	G	SOLID CORE	PAINT	2' - 6" x 6' -	- 8" 1 1/2"	-	WOOD	PAINT	LEVER	N/A	SINGLE BIFOLD DOOR C/W SOFT GLIDE TRACK
100c	ENTRY	-	LAUNDRY	′ G	SOLID CORE	PAINT	2' - 6" x 6' -	- 8" 1 1/2"	-	WOOD	PAINT	LEVER	N/A	SINGLE BIFOLD DOOR C/W SOFT GLIDE TRACK
101a	ENTRY		P/R	E	SOLID CORE		2' - 4" x 6' -	- 8" 1 1/2"						POCKET DOOR C/W SOFT GLIDE TRACK
105a	LIVING	-	BEDROOM	M E	SOLID CORE	PAINT	2' - 6" x 6' -	- 8" 1 1/2"	-	WOOD	PAINT	LINEAR PULL	N/A	POCKET DOOR C/W SOFT GLIDE TRACK
105b	BEDROOM		ENS.	С	SOLID CORE		2' - 4" x 6' -	- 8" 1 1/2"						SWING DOOR
107a	DINING		OFFICE	F	SOLID CORE	PAINT	9' - 8 1/2" x	(7' - 6" 1 1/2"	-	WOOD	PAINT	LINEAR PULL	N/A	4-PANEL BYPASS SLIDING DOOR C/W SOFT GLIDE TRACK

GROUND FLOOR: 7

NOTE:

ALL FINISH / HARDWARE SELECTIONS TBD BY CLIENT


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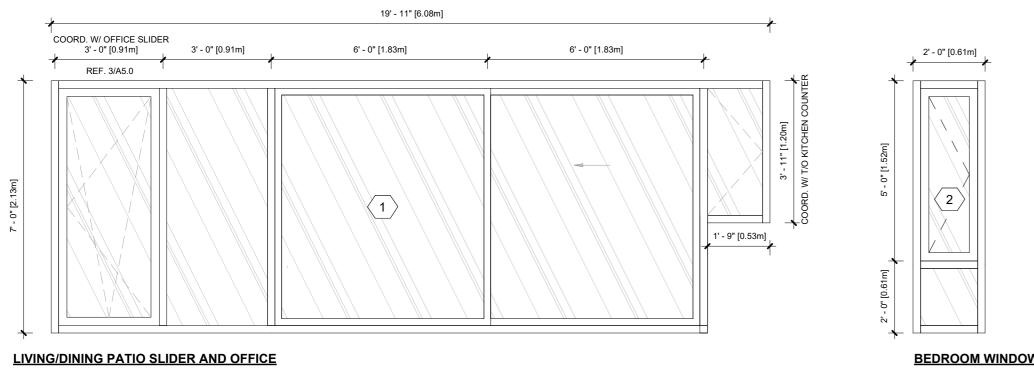
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DOOR TYPES




WINDOW SCHEDULE

COUNT: 1
DOUBLE GLAZED, THERMALLY BROKEN VINYL FRAME, BLACK FINISH
TILT & TURN, FIXED PANEL, SLIDER, AND CASEMENT AS INDICATED

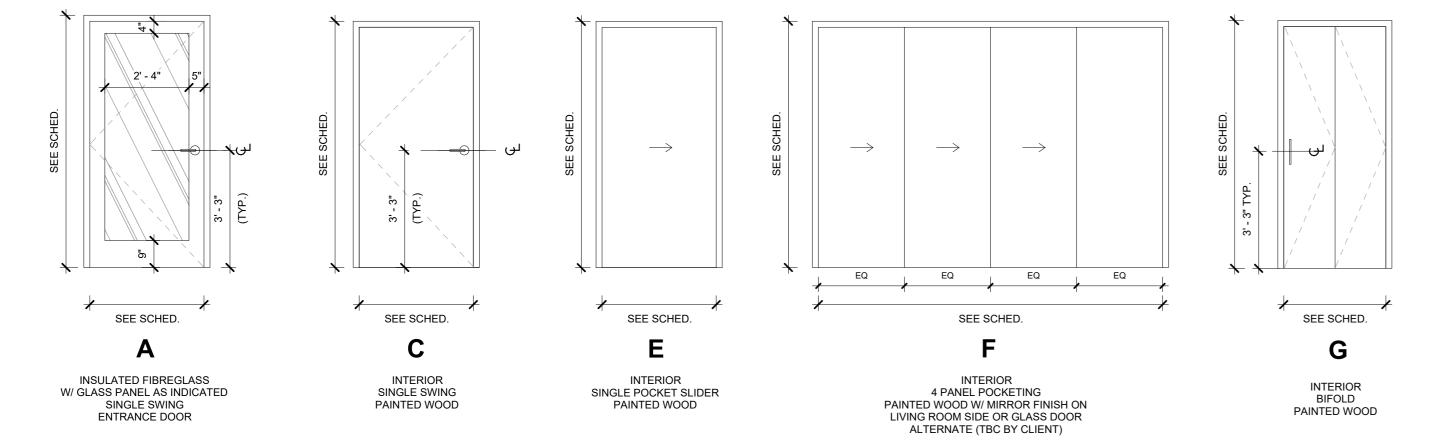

BEDROOM WINDOW


COUNT: 1
DOUBLE GLAZED, THERMALLY BROKEN VINYL FRAME,
BLACK FINISH
FIXED PANELS AND CASEMENT AS INDICATED

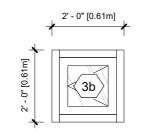

ENSUITE AND POWDER WINDOWS

COUNT: 2
DOUBLE GLAZED, THERMALLY BROKEN VINYL FRAME,
BLACK FINISH

CASEMENT AS INDICATED

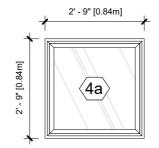

TYP. DECK-MOUNTED SLOPED ROOF SKYLIGHT

COUNT: 2 VELUX CURB MOUNT SKYLIGHT FCM-FIXED CURB MOUNT 3030 **LANE** SCAPE

LANESCAPE ARCHITECTURE INC. 282 RICHMOND ST E., SUITE 200 TORONTO, ON M5A 1P4 416 414 9944 x 0

SUITE

PROJECT SCHEDULE
ISSUED FOR PERMIT

DRAWN

CHECKED SCALE

DATE JOB NO

SHEET

A8.0